

Fixture Schedule



City of San Jose Interim Lighting Policy

Broad Spectrum Lighting (LED)

for Private Development

A Permit Adjustment which includes the following information and demonstrates conformance with the identified standards is required in order to obtain approval for an exception to the required use of Low Pressure Sodium Lighting on private development:

Outdoor Lighting Plan

Provide an Outdoor Lighting Plan including:

- HTING SHEET → ☐ Luminaire Schedule (number, lamp type, wattage, color rendering index (CRI), Correlated Color Temperature (CCT), Backlight, Uplight, and Glare (BUG) Rating, pole height, distribution type)
 - HTING 1.2A → ☐ Photometric grid showing illumination levels from all exterior light sources (per LM-79-08¹).
 - HTING → ☐ Manufacturers specification for all proposed lighting fixtures.

Illumination Levels

- CBEA Site Lighting Performance Specification for Light Zone 2
http://apps1.eere.energy.gov/buildings/publications/pdfs/alliances/cbea_led_site_lighting_spec.pdf
 - IESNA RP-33-99 Lighting for Exterior Environments
 - IESNA RP-8-00 - Standard Practice for Roadway Lighting,(Private Streets & Adjacent Sidewalks)
 - IESNA DG-5-94 – Recommended Lighting for Walkways and Class 1 Bikeways
 - IESNA RP-20-98 – Lighting for Parking Facilities
 - Average illumination levels not exceeding IESNA standards by more than 0.2 foot candles

Backlight, Uplight & Glare

- CALGreen Nonresidential Mandatory Measures 5.106.8 - Maximum BUG Ratings.¹ (Lighting Zone 3)
 - Zoning Code Section 20.40.530:
 - Light fixture heights should not exceed eight feet when adjacent to residential uses unless the setback of the fixture from property line is twice the height of the fixture.
 - No ground mounted light fixture shall exceed twenty-five feet in height.
 - Any lighting located adjacent to riparian areas shall be directed downward and away from riparian

Contributors

- HTING SHEET** → The Correlated Color Temperature (CCT) should fall within the recommended range of (3500-4300K) in accordance with the City of San Jose Public Streetlight Design Guide as amended.

Light Level must be reduced for a mini

- later than 12 AM.

- HTING
SHEET** → ☐ Light Level must be reduced for a minimum of 6 hours with a 50% light level reduction, beginning no later than 12 AM.

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'D' FIXTURES ARE DECORATIVE BY OTHERS

REV	ISSUED FOR	DATE
	CUP	01/07/20
	SUP REV1	03/26/21
	SUP REV2	10/19/21

WAT KHMER KAMPUCHEA KROM
2740 RUBY AVENUE
SAN JOSE, CALIFORNIA 95148
APN: 6522-29-014
PROJECT FILE NO. SP20-024

ANDREW MANN ARCHITECTURE

360 LANGTON STREET, SUITE 302
SAN FRANCISCO, CALIFORNIA, 94103
TELEPHONE: 415-863-4134
ANDREWMANNARCHITECTURE.COM

E J A

LIGHTING DESIGN
BEYOND ILLUMINATION

201 ALAMEDA DEL PRADO, SUITE 204
NOVATO, CALIFORNIA, 94903
TELEPHONE: 415-482-0923
EJALIGHTING.COM

SHEET TITLE:


**SUP APPLICATION
LIGHTING
SCHEDULE**

ORIGINAL SHEET ISSUE DATE:
03/26/2021

SCALE:	DRAWN BY:
NA	MW

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EL-S

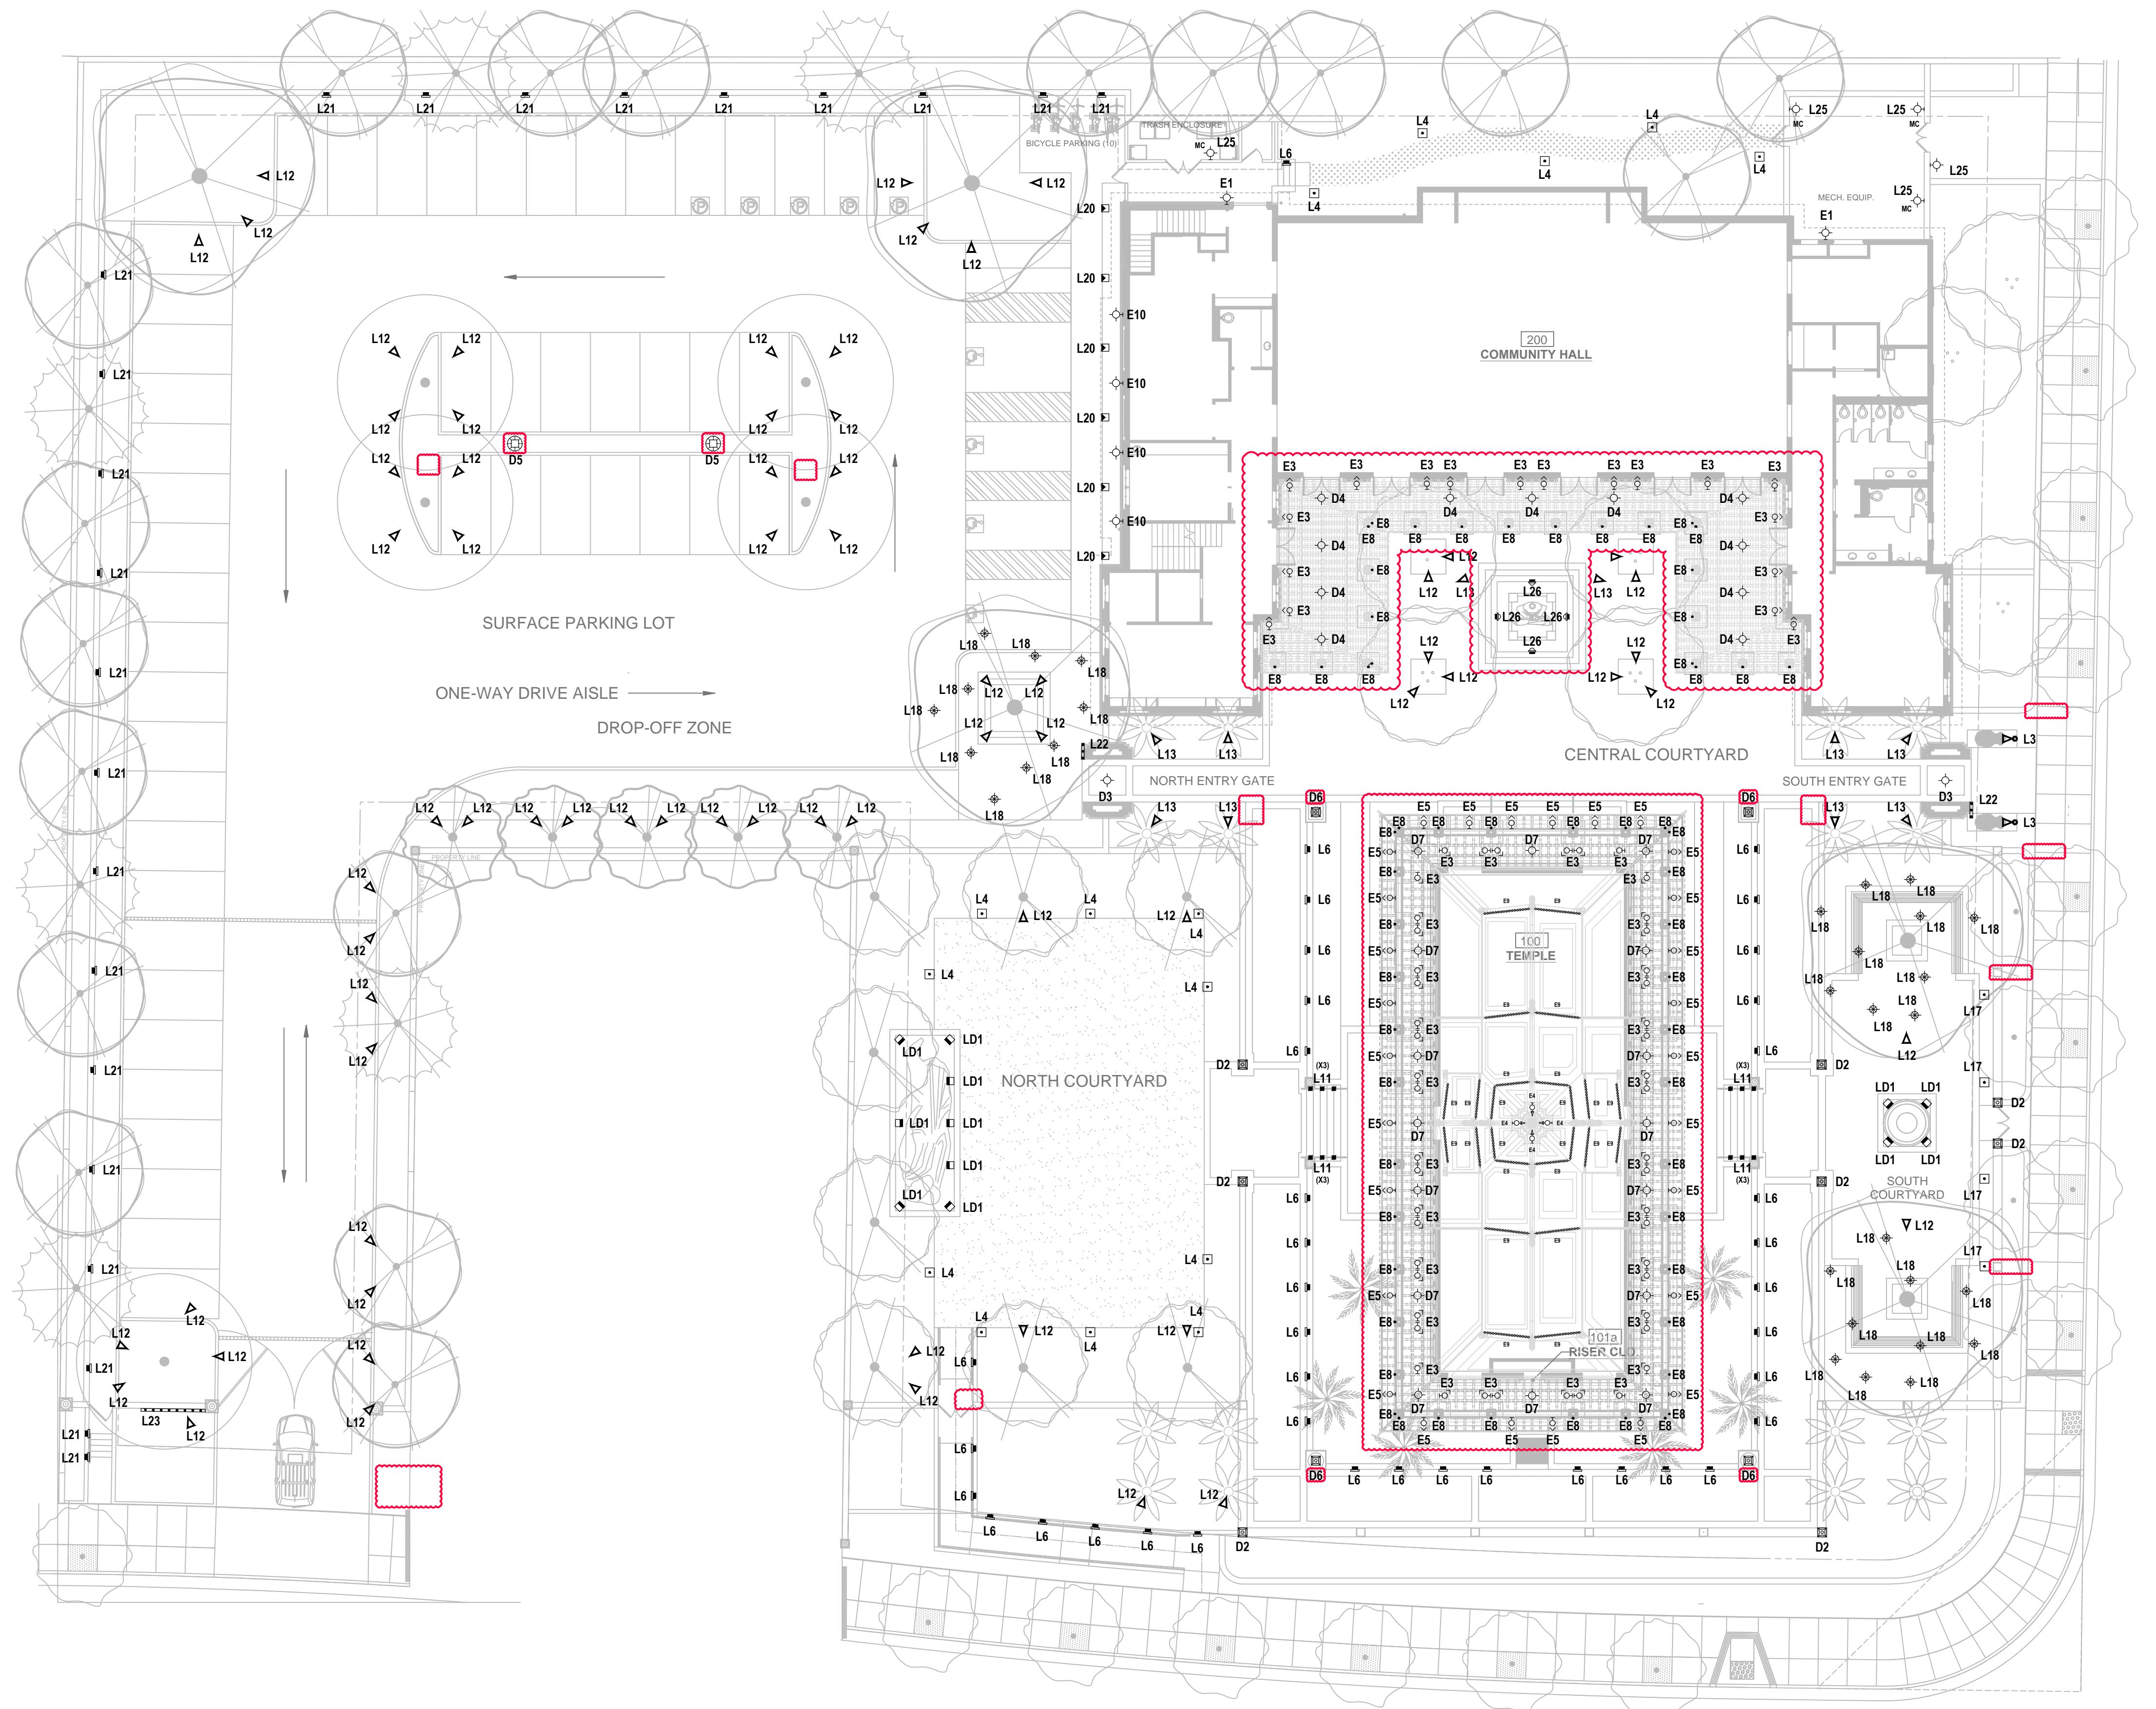

WAT KHMER KAMPUCHEA KROM

2740 RUBY AVENUE

SAN JOSE, CALIFORNIA 95148

APN: 652-29-014

PROJECT FILE NO. SP20-024

ANDREW MANN ARCHITECTURE

360 LANGSTON STREET, SUITE 302

SAN FRANCISCO, CALIFORNIA 94103

TELEPHONE: 415-865-4134

ANDREWMANNArchitecture.com

EJA

LIGHTING DESIGN

REVISED ILLUMINATION

201 ALAMEDA DE PRADO, SUITE 204

NOVATO, CALIFORNIA 94945

TELEPHONE: 415-482-0923

EJALighting.com

SHEET TITLE:
 SUP APPLICATION
 OVERALL
 SITE PLAN
 LIGHTING

ORIGINAL SHEET ISSUE DATE:
 03/26/2021

SCALE: 1/16" = 1'-0"
 DRAWN BY: MW

SHEET NUMBER:



TRUE NORTH

N

L1.2

