PROJECT DESCRIPTION

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THE PROJECT PROPOSES THE CONSTRUCTION OF A TRADITIONAL CAMBODIAN BUDDHIST TEMPLE TO SERVE THE EXISTING LOCAL KHMER KROM RELIGIOUS COMMUNITY, WHOSE CURRENT TEMPLE FUNCTIONS OUT OF A CONVERTED RESIDENCE AT A DIFFERENT SITE IN SAN JOSE. THE PROJECT INCLUDES THE REZONING OF THE SITE TO THE PUBLIC/QUASI-PUBLIC ZONING DISTRICT, WHICH ALLOWS CHURCH/RELIGIOUS ASSEMBLY USES UPON ISSUANCE OF A SPECIAL USE PERMIT. TWENTY TWO ORDINANCE-SIZE TREES ARE PROPOSED TO BE REMOVED. THE PROJECT SIZE AND TOTAL SQUARE FOOTAGE ARE DESIGNED TO MEET THE MINIMUM NEEDS OF THE RELIGIOUS COMMUNITY. IT IS COMPRISED OF TWO BUILDINGS - A TEMPLE SANCTUARY AND COMMUNITY BUILDING - EACH SET ON EITHER SIDE OF A MAIN CENTRAL COURTYARD. THE PROJECT IS SERVED BY A SURFACE PARKING LOT WITH AN ENTRY DRIVE LOCATED ALONG RUBY AVE. THE MAIN COURTYARD SERVES AS THE ENTRY POINT FOR ALL TEMPLE VISITORS VIA TWO CEREMONIAL ENTRY GATES, ONE AT EACH SIDE WHICH REPRESENT THE FORMAL ENTRY TO SACRED SPACE. THE SOUTH GATE PROVIDES ACCESS DIRECTLY FROM THE SIDEWALK ON NORWOOD AVENUE WHILE THE NORTH GATE GIVES ACCESS FROM THE PARKING LOT AT THE INTERIOR OF THE SITE.

THE TEMPLE SANCTUARY BUILDING IS INTENDED FOR RELIGIOUS WORSHIP AND MEDITATION SERVICES. AS THE MOST IMPORTANT BUILDING, IT IS ORIENTED TO THE PUBLIC CORNER OF THE SITE NEAREST THE INTERSECTION OF RUBY AND NORWOOD AVENUES. IT IS INTENTIONALLY SET BACK FROM THE SIDEWALKS, ALLOWING GARDEN SPACES TO WRAP ALONG THE TWO STREET FRONTAGES ON THIS CORNER PROPERTY. A PERIMETER ARCADE PROVIDES SHADED CIRCULATION SPACE PROTECTED FROM THE ELEMENTS. BEYOND IN THE LANDSCAPE, A WALKWAY FOR RELIGIOUS PROCESSION FOLLOWS THE GARDENS AROUND THREE SIDES OF THE BUILDING. THE FOURTH SIDE FACES THE COMMUNITY BUILDING AND THE TWO BUILDINGS TOGETHER FORM A MAIN COURTYARD AT THE INTERIOR OF THE SITE.

THE COMMUNITY BUILDING IS A MULTI-USE STRUCTURE CHARACTERIZED BY A SERIES OF SMALLER ROOF VOLUMES WHICH SUBDIVIDE THE BUILDING INTO THREE DISTINCT WINGS OF VARYING HEIGHTS CORRESPONDING TO ITS HORSESHOE-SHAPED GEOMETRY. A COVERED ARCADE WRAPS THE THREE INWARD SIDES FORMING THE MAIN COURTYARD. THE MAJORITY OF THE BUILDING IS OF A SINGLE STORY. IT HOUSES ON THE FIRST FLOOR A COMMUNITY HALL FOR GATHERING AND CELEBRATION OF MEALS; A FINISHING KITCHEN; A RELIGIOUS LIBRARY WHICH ALSO ACTS AS A RELIGIOUS CLASSROOM; AND OFFICE AND BATHROOM SPACES. A SMALL PORTION OF THE COMMUNITY BUILDING HAS A SECOND FLOOR, INTENTIONALLY LOCATED AT ITS NORTHERN SIDE AT THE MOST INTERIOR AND PRIVATE PORTION OF THE PROPERTY. THE SECOND FLOOR HOUSES THE MONKS' RESIDENCE FOR 8 FULLTIME RESIDENTS OF THE PROPERTY. SMALL BASEMENT SPACES ARE PROVIDED IN BOTH BUILDINGS FOR MECHANICAL AND ELECTRICAL EQUIPMENT.

THE BUILDING FORMS AND PERIMETER WALLS CREATE OUTDOOR SPACES IN THE FORM OF COURTYARDS AND GARDENS, ENHANCED BY PLANTINGS, TREES, AND A FOUNTAIN. THE GARDENS CONTAIN SACRED SPACES FOR QUIET MEDITATION AND REFLECTION BY BOTH RESIDENTS AND VISITORS. FULL SIDEWALK AND STREET FRONTAGE IMPROVEMENTS ARE PROPOSED INCLUDING NEW STREET TREES AND PLANTING ALONG BOTH RUBY AND NORWOOD AVENUES.


THE PROJECT IS BOTH COMPATIBLE WITH AND COMPLIMENTARY TO THE SURROUNDING NEIGHBORHOOD IN TERMS OF SITE PLACEMENT, BUILDING SCALE, AND USE OF COMMON BUILDING ELEMENTS SUCH AS HIPPED AND GABLE ROOF FORMS, COVERED PORCHES, FINISH MATERIALS AND LANDSCAPING. THE PROJECT'S USE AND OPERATION PLAN ARE ALSO COMPARABLE TO THOSE OF OTHER NEARBY RELIGIOUS ASSEMBLY USES.

SYMBOLS LEGEND

SETBACK LINE

---- OVERHEAD

DATUM OR CONTROL POINT

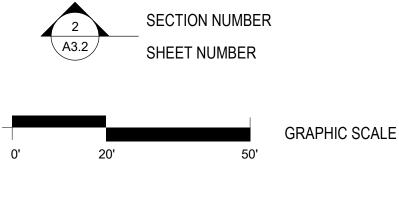

SHEET NUMBER

EXTERIOR ELEVATION NUMBER

+

PROJECT DIRECTORY

NORTH ARROW

CLIENT:

A Khmer Buddhist Foundation 1210 Lombard Street San Francisco, CA 94109 CONTACT: Lyna Lam, President & Director lyna@watkhmerkampucheakrom.org

ARCHITECTS:

Andrew Mann Architecture 360 Langton Street, Suite 302 San Francisco, CA 94103 CONTACT: Andrew Mann, Principal andrew@andrewmannarchitecture.com (415) 863-4134

Siegel & Strain Architects 6201 Doyle Street, Suite B Emeryville, CA 94608 CONTACT: Susi Marzuola, Principal susi@siegelstrain.com (510) 547-8092

GENERAL CONTRACTOR:

A4.1

OARCON Inc. 2180 Bryant Street Suite 109 San Francisco, CA 94110 CONTACT: Vince O'Driscoll vince@oarcon.com

LANDSCAPE ARCHITECT: Strata Landscape Architecture 136 Freelon Street San Francisco, CA 94107 CONTACT: Todd Cole, Principal tcole@strata-inc.com (415) 431-9200

INTERIOR DESIGN: Antonio Martins Interior Design 550 15th Street, Suite 32 San Francisco, CA 94103 CONTACT: Antonio Martins, Principal AM@antoniomartins.com (415) 624-3671

PROJECT DATA

PROPERTY INFORMATION: PROPERTY ADDRESS (PRIMARY) 2740 RUBY AVENUE, SAN JOSE, CA 95148 APN# 652-29-014 ZONING DESIGNATION (EXISTING) R-1-5, (PROPOSED) PQP PROPOSED USE CHURCH/RELIGIOUS ASSEMBLY **ZONING INFORMATION (PQP)**:** SETBACKS: **REQUIRED:** PROPOSED*: FRONT (WEST) 32' - 1" 10' FRONT (SOUTH) 10' 10' - 1" SIDE (NORTH) 10' 60' - 0" SIDE (EAST) 10' 137' - 4" SIDE (SOUTH) 10' 93' - 0" **REAR (NORTH)** 10' 172' - 5" REAR (EAST) 10' 22' - 2" PROJECT FLOOR AREA ** ALLOWABLE: PROPOSED: NA 11.491 SF

NA

NA

2,411 SF

13,902 SF

FIRST FLOOR SECOND FLOOR

TOTAL PROJECT FLOOR AREA



STRUCTURAL ENGINEER:

GFDS Engineers 99 Green Street, 3rd Floor San Francisco, CA 94111 CONTACT: Kris Johnson, Principal kjohnson@gfdseng.com (415) 512-1301

ELECTRICAL ENGINEER:


O'Mahony & Myer 4340 Redwood Highway, Suite 245 San Rafael, CA 94903 CONTACT: Pieter Colenbrander, Principal pcolenbrander@ommconsulting.com (415) 492-0420

LIGHTING DESIGNER:

Eric Johnson Associates 201 Alameda Del Prado, Suite 204 Novato, CA 94949 CONTACT: Eric Johnson, Principal ej@ejalighting.com (415) 482-0923

2740 RUBY AVENUE WAT KHMER KAMPUCHEA KROM TEMPLE

ZONING INFORMATION (PQP)** CONTINUED:			
	ALLOWABLE:	PROPOSED:	
LOT SIZE (AREA):	MIN 6,000 SF	81,022 SF (1.86 ACRES)	
MAXIMUM BUILDING HEIGHT**	65'	TEMPLE ROOF: 43'-4 1/2" TO SPIRE: 64'-10" COMMUNITY BUILDING ROOF: 35'-0"	
NOISE STANDARD	<54 DBA	51 DBA	
	REQUIRED:	PROPOSED:	
PARKING (CAR)	66	68	
EV CHARGING STATIONS	7	7	
ACCESSIBLE PARKING	4	4	
PARKING (BICYCLE)	5	10	

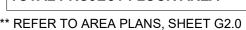



CIVIL ENGINEER: Lea Braze Engineering 2495 Industrial Pkwy West Hayward, CA 94545 CONTACT: Jim Toby, Principal

jtoby@leabraze.com

(510) 887-4086

ARBORIST:

Urban Tree Management, Inc. P.O. Box 971 Los Gatos, CA 95031 CONTACT: Michael Young, Principal office@urbantreemanagement.com (650) 321-0202

MECHANICAL / PLUMBING ENGINEER: Taylor Engineering 1080 Marina Village Parkway, Suite 501 Alameda, CA 94501 CONTACT: Glenn Friedman, Principal gfriedman@taylor-engineering.com (510) 749-9135

GEOTECHNICAL ENGINEER:

Divis Consulting 4398 Mission Street San Francisco, CA 94112 CONTACT: Christian Divis christian@divisconsulting.com (415) 420-3498

ACOUSTIC CONSULTANT:

Wilson, Ihrig & Associates 6001 Shellmound Street, Suite 400 Emeryville, CA 94608 CONTACT: Pablo Daroux, Principal pdaroux@wiai.com (510) 658-6719

COMMUNITY OUTREACH:

Canyon Snow Consulting LLC 459 Monterey Avenue Los Gatos, CA 95030 CONTACT: Jennifer Johnson, Principal jenniferjohnson@canyonsnow.com (408) 317-0416

KITCHEN/FOOD SERVICE:


Cini Little International, Inc. 156 2nd Street, Suite 406 San Francisco, CA 94105 CONTACT: Keith Short, Director of Design kshort@cinilittle.com (626) 463-7680

TRANSPORTATION CONSULTANT: Hexagon Transportation Consultants, Inc. 4 N 2nd St #400 San Jose, CA 95113 CONTACT: Gary Black, President gblack@hextrans.com (408) 971-6100

ENVIRONMENTAL CONSULTANT: David J. Powers & Associated, Inc. 1871 The Alameda, Suite 200 San Jose, CA 95126 CONTACT: Mike Campbell, Project Manager mcampbell@davidjpowers.com (408) 454-3425

BUILDING INFORMATION: REFER G5.0 & G5.1 FOR DETAILED BUILDING CODE COMPLIANCE DIAGRAMS AND INFORMATION					
	2ND FLOOR 1ST FLOOR BAS		SEMENT		
	COMMUNITY BUILDING	COMMUNITY BUILDING	TEMPLE	COMMUNITY BUILDING	TEMPLE
OCCUPANCY CLASS:	R-3	A-3	A-3	S-2	S-2
CONSTRUCTION TYPE:	VB				
FIRE SPRINKLER DESIGNATION			S		

VICINITY MAP

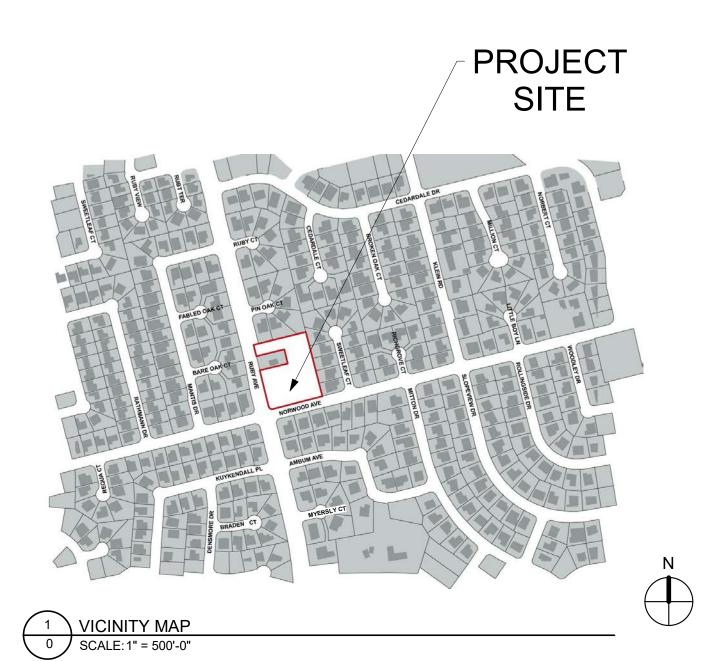

APPLICABLE CODES

- 2019 CALIFORNIA BUILDING CODE 2019 CALIFORNIA PLUMBING CODE
- 2019 CALIFORNIA ENERGY CODE
- 2019 CALIFORNIA FIRE CODE
- 2019 CALIFORNIA GREEN BUILDING CODE 2019 CALIFORNIA MECHANICAL CODE
- 2019 CALIFORNIA ELECTRICAL CODE

REVISSUED FORDATECUP01/07/20REV 1 SUP03/26/21REV 2 SUP10/19/21REV 3 SUP02/09/22NOILONULSUONOILONULSUO	
ANDREW H. MANN * C 26086 BEN. 3/31/23 TIL OF CALIFORN	
WAT KHMER KAMPUCHEA KROM 2740 RUBY AVENUE SAN JOSE, CALIFORNIA 95148 APN: 652-29-014 PROJECT FILE NO. SP20-024	
ANDREW MANN ARCHITECTURE 360 LANGTON STREET, SUITE 302 SAN FRANCISCO, CALIFORNIA, 94103 TELEPHONE: 415-863-4134 ANDREWMANNARCHITECTURE.COM	
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ORIGINAL SHEET ISSUE DATE: 01/07/20 SCALE: As indicated SHEET NUMBER: O	

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1			
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S1.1 S2.0	ARCHITECTURAL SITE PLAN (SUP)	AMA STRATA	03/26/2
S2.0 S3.0	CIVIL SITE PLAN	L&B	03/26/2
S3.1	CIVIL SITE PLAN	L&B	03/26/2
S3.2 S4.0	CIVIL SITE PLAN LIGHTING SITE PLAN	L&B EJA	03/26/2
7 GENERA			
G1.0	AERIAL PHOTO - EXISTING PLAN	AMA	01/07/2
G1.1 G2.0	AERIAL PHOTO - PROPOSED PLAN AREA PLANS	AMA AMA	01/07/2
G2.0 G3.0	PARKING COUNT DIAGRAM	AMA	03/26/2
G4.0	BUILDING HEIGHT DIAGRAMS	AMA	01/07/2
G5.0 G5.1	BUILDING CODE ANALYSIS EGRESS ANALYSIS	S&S S&S	03/26/2
G6.0	SITE PHOTOS	AMA	01/07/2
G7.0 G7.1	COMPATIBILITY EXHIBITS COMPATIBILITY EXHIBITS	AMA AMA	03/26/2
G7.2	COMPATIBILITY EXHIBITS	AMA	03/26/2
G7.3 12	COMPATIBILITY EXHIBITS	AMA	03/26/2
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A0.0	GENERAL NOTES & ABBREVIATIONS	AMA	01/07/2
A1.0 A1.1	BASEMENT FLOOR PLAN FIRST FLOOR PLAN	AMA AMA	01/07/2
A1.2	SECOND FLOOR PLAN	AMA	03/26/2
A1.3 A2.0	ROOF PLAN WEST & SOUTH EXTERIOR ELEVATIONS	AMA	01/07/2
A2.1	EAST & NORTH EXTERIOR ELEVATIONS	AMA	01/07/2
A2.2 A2.3	SITE SECTIONS SITE SECTIONS	AMA AMA	01/07/2
A5.0	RENDERINGS	AMA	03/26/2
A5.1 A6.0	RENDERINGS BUILDING MATERIAL ELEVATIONS	AMA AMA	03/26/2
A6.1	BUILDING MATERIAL ELEVATIONS	AMA	01/07/2
A6.2 A6.3	ENLARGED BUILDING MATERIALS KEY ENLARGED LANDSCAPE MATERIALS KEY	AMA AMA	03/26/2
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T-01	TOPOGRAPHIC MAP	G&K	12/01/2
1 CIVIL			
C-1.0	TITLE SHEET	L&B	12/01/2
C-2.0 C-2.1	OVERALL SITE PLAN GRADING AND DRAINAGE PLAN	L&B L&B	12/01/2
C-2.2	GRADING AND DRAINAGE PLAN	L&B	12/01/2
C-2.3	GRADING AND DRAINAGE PLAN	L&B	12/01/2
C-2.4 C-2.5	GRADING AND DRAINAGE PLAN SITE SECTIONS	L&B L&B	12/01/2
C-2.6	SITE SECTIONS	L&B	12/01/2
C-3.0		L&B L&B	12/01/2
C-4 0	GRADING SPECIFICATIONS		12/01/2
	GRADING SPECIFICATIONS FIRE HYDRANT AND ACCESS PLAN	L&B	12/01/2
FC-1 FC-2	FIRE HYDRANT AND ACCESS PLANFIRE FLOW RESULT AND MAP	L&B L&B	12/01/2
FC-1 FC-2 BMP	FIRE HYDRANT AND ACCESS PLAN	L&B	12/01/2 12/01/2
FC-1 FC-2 BMP SCP-1 SCP-2	FIRE HYDRANT AND ACCESS PLANFIRE FLOW RESULT AND MAPBEST MANAGEMENT PRACTICEIMPERVIOUS SURFACE EXHIBITSTORMWATER CONTROL PLAN	L&B L&B L&B L&B L&B L&B	12/01/2 12/01/2 12/01/2 12/01/2
FC-1 FC-2 BMP SCP-1 SCP-2 SCP-3	FIRE HYDRANT AND ACCESS PLANFIRE FLOW RESULT AND MAPBEST MANAGEMENT PRACTICEIMPERVIOUS SURFACE EXHIBIT	L&B L&B L&B L&B L&B	12/01/2 12/01/2 12/01/2 12/01/2 12/01/2
FC-1 FC-2 BMP SCP-1 SCP-2 SCP-3 SCP-3 SCP-4 SCP-5	FIRE HYDRANT AND ACCESS PLANFIRE FLOW RESULT AND MAPBEST MANAGEMENT PRACTICEIMPERVIOUS SURFACE EXHIBITSTORMWATER CONTROL PLANSTORMWATER CONTROL NOTESSTORMWATER TREATMENT DETAILSSTORMWATER CONTROL DETAILS	L&B L&B L&B L&B L&B L&B L&B L&B L&B	12/01/2 12/01/2 12/01/2 12/01/2 12/01/2 12/01/2 12/01/2
FC-1 FC-2 BMP SCP-1 SCP-2 SCP-3 SCP-3 SCP-4 SCP-5 SCP-6	FIRE HYDRANT AND ACCESS PLANFIRE FLOW RESULT AND MAPBEST MANAGEMENT PRACTICEIMPERVIOUS SURFACE EXHIBITSTORMWATER CONTROL PLANSTORMWATER CONTROL NOTESSTORMWATER TREATMENT DETAILSSTORMWATER CONTROL DETAILSSTORMWATER CONTROL DETAILS	L&B L&B L&B L&B L&B L&B L&B L&B	12/01/2 12/01/2 12/01/2 12/01/2 12/01/2 12/01/2 12/01/2 12/01/2
FC-1 FC-2 BMP SCP-1 SCP-2 SCP-3 SCP-3 SCP-4 SCP-5 SCP-6 SCP-7	FIRE HYDRANT AND ACCESS PLANFIRE FLOW RESULT AND MAPBEST MANAGEMENT PRACTICEIMPERVIOUS SURFACE EXHIBITSTORMWATER CONTROL PLANSTORMWATER CONTROL NOTESSTORMWATER TREATMENT DETAILSSTORMWATER CONTROL DETAILSSTORMWATER CONTROL DETAILSHYDROMODITICATION MANAGEMENT (HM) PLAN (PRE-CONSTRUCTION)	L&B L&B L&B L&B L&B L&B L&B L&B L&B L&B	12/01/2 12/01/2 12/01/2 12/01/2 12/01/2 12/01/2 12/01/2 12/01/2 12/01/2
FC-1 FC-2 BMP SCP-1 SCP-2 SCP-3 SCP-3 SCP-4 SCP-5 SCP-6 SCP-7 SCP-8	FIRE HYDRANT AND ACCESS PLANFIRE FLOW RESULT AND MAPBEST MANAGEMENT PRACTICEIMPERVIOUS SURFACE EXHIBITSTORMWATER CONTROL PLANSTORMWATER CONTROL NOTESSTORMWATER TREATMENT DETAILSSTORMWATER CONTROL DETAILSSTORMWATER CONTROL DETAILSHYDROMODITICATION MANAGEMENT (HM) PLAN	L&B L&B L&B L&B L&B L&B L&B L&B L&B L&B	12/01/2 12/01/2 12/01/2 12/01/2 12/01/2 12/01/2 12/01/2 12/01/2 12/01/2
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FC-1 FC-2 BMP SCP-1 SCP-2 SCP-3 SCP-3 SCP-4 SCP-5 SCP-6 SCP-7 SCP-7 SCP-8 21 LANDSC/ L0.0 L0.1	FIRE HYDRANT AND ACCESS PLAN FIRE FLOW RESULT AND MAP BEST MANAGEMENT PRACTICE IMPERVIOUS SURFACE EXHIBIT STORMWATER CONTROL PLAN STORMWATER CONTROL NOTES STORMWATER TREATMENT DETAILS STORMWATER CONTROL DETAILS STORMWATER CONTROL DETAILS STORMWATER CONTROL DETAILS STORMWATER CONTROL DETAILS HYDROMODITICATION MANAGEMENT (HM) PLAN (PRE-CONSTRUCTION) HYDROMODITICATION MANAGEMENT (HM) PLAN (PRE-CONSTRUCTION)	L&B L&B L&B L&B L&B L&B L&B L&B L&B L&B	12/01/2 12/01/2 12/01/2 12/01/2 12/01/2 12/01/2 12/01/2 12/01/2 12/01/2
FC-2 BMP SCP-1 SCP-2 SCP-3 SCP-4 SCP-5 SCP-6 SCP-7 SCP-8 21 LANDSC/ L0.0 L0.1 L0.2 L0.3	FIRE HYDRANT AND ACCESS PLAN FIRE FLOW RESULT AND MAP BEST MANAGEMENT PRACTICE IMPERVIOUS SURFACE EXHIBIT STORMWATER CONTROL PLAN STORMWATER CONTROL NOTES STORMWATER TREATMENT DETAILS STORMWATER CONTROL DETAILS HYDROMODITICATION MANAGEMENT (HM) PLAN (PRE-CONSTRUCTION) HYDROMODITICATION MANAGEMENT (HM) PLAN (PRE-CONSTRUCTION) HYDROMODITICATION MANAGEMENT (HM) PLAN (PRE-CONSTRUCTION) TREE REMOVAL & DEMOLITION PLAN TREE SURVEY DATA PLAN TREE SURVEY DATA PLAN	L&B STRATA STRATA STRATA STRATA STRATA STRATA	12/01/2 12/01/2 12/01/2 12/01/2 12/01/2 12/01/2 12/01/2 12/01/2 12/01/2 12/01/2 12/01/2 12/01/2 12/01/2 12/01/2 12/01/2
FC-1 FC-2 BMP SCP-1 SCP-2 SCP-3 SCP-3 SCP-4 SCP-5 SCP-6 SCP-7 SCP-7 SCP-8 21 LANDSC/ L0.0 L0.1 L0.2 L0.3 L1.0	FIRE HYDRANT AND ACCESS PLAN FIRE FLOW RESULT AND MAP BEST MANAGEMENT PRACTICE IMPERVIOUS SURFACE EXHIBIT STORMWATER CONTROL PLAN STORMWATER CONTROL NOTES STORMWATER TREATMENT DETAILS STORMWATER CONTROL DETAILS HYDROMODITICATION MANAGEMENT (HM) PLAN (PRE-CONSTRUCTION) HYDROMODITICATION MANAGEMENT (HM) PLAN (PRE-CONSTRUCTION) HYDROMODITICATION MANAGEMENT (HM) PLAN (PRE-CONSTRUCTION) TREE REMOVAL & DEMOLITION PLAN TREE SURVEY DATA PLAN TREE SURVEY DATA PLAN LAYOUT PLAN	L&B STRATA	12/01/2 12/01/2 12/01/2 12/01/2 12/01/2 12/01/2 12/01/2 12/01/2 12/01/2 12/01/2 12/01/2 12/01/2 12/01/2 12/01/2 12/01/2 12/01/2 12/01/2
FC-1 FC-2 BMP SCP-1 SCP-2 SCP-3 SCP-4 SCP-5 SCP-6 SCP-7 SCP-7 SCP-8 21 LANDSC/ L0.0 L0.1 L0.2 L0.3 L1.0 L2.0	FIRE HYDRANT AND ACCESS PLAN FIRE FLOW RESULT AND MAP BEST MANAGEMENT PRACTICE IMPERVIOUS SURFACE EXHIBIT STORMWATER CONTROL PLAN STORMWATER CONTROL NOTES STORMWATER TREATMENT DETAILS STORMWATER CONTROL DETAILS HYDROMODITICATION MANAGEMENT (HM) PLAN (PRE-CONSTRUCTION) HYDROMODITICATION MANAGEMENT (HM) PLAN (PRE-CONSTRUCTION) HYDROMODITICATION MANAGEMENT (HM) PLAN (PRE-CONSTRUCTION) TREE REMOVAL & DEMOLITION PLAN TREE SURVEY DATA PLAN TREE SURVEY DATA PLAN	L&B STRATA STRATA STRATA STRATA STRATA STRATA	12/01/2 12/01/2 12/01/2 12/01/2 12/01/2 12/01/2 12/01/2 12/01/2 12/01/2 12/01/2 12/01/2 12/01/2 12/01/2 12/01/2 12/01/2
FC-1 FC-2 BMP SCP-1 SCP-2 SCP-3 SCP-4	FIRE HYDRANT AND ACCESS PLAN FIRE FLOW RESULT AND MAP BEST MANAGEMENT PRACTICE IMPERVIOUS SURFACE EXHIBIT STORMWATER CONTROL PLAN STORMWATER CONTROL NOTES STORMWATER TREATMENT DETAILS STORMWATER CONTROL DETAILS HYDROMODITICATION MANAGEMENT (HM) PLAN (PRE-CONSTRUCTION) HYDROMODITICATION MANAGEMENT (HM) PLAN (PRE-CONSTRUCTION)	L&B STRATA STRATA	12/01/2 12/01/2 12/01/2 12/01/2 12/01/2 12/01/2 12/01/2 12/01/2 12/01/2 12/01/2 12/01/2 12/01/2 12/01/2 12/01/2 12/01/2 12/01/2 12/01/2

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wn By	Date	Number L4.2	Sheet Name PLANTING PLAN	Drawn By STRATA	Date 12/01/21	
	01/07/20	L4.2 L4.3	PLANTING PLAN PLANTING PLAN	STRATA	12/01/21	Z
	01/07/20	L4.4	PLANT LIST AND NOTES	STRATA	12/01/21	
	J	L4.5	PLANTING DETAILS	STRATA	12/01/21	ဗီပ်
	04/07/00	L6.0	PAVING DETAILS	STRATA	12/01/21	NOT FOR CONSTRUCTION
	01/07/20	L6.1 L6.2	WALL DETAILS STEPS AND RAILINGS DETAILS	STRATA STRATA	12/01/21	
		L6.2 L6.3	SPECIALTY DETAILS	STRATA	12/01/21	
	03/26/21	L6.4	SPECIALTY DETAILS	STRATA	12/01/21	
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TA	03/26/21	L6.6	SPECIALTY DETAILS	STRATA	12/01/21	
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	03/26/21		3			
	03/26/21	EL-S	LIGHTING SCHEDULE	EJA	01/07/20	CO ARO
		L1.2	OVERALL SITE PLAN LIGHTING	EJA	01/07/20	SENSED ARCHITES
	01/07/20	L1.2A L1.3	OVERALL SITE PLAN PHOTOMETRIC GRID TEMPLE ROOF PLAN LIGHTING	EJA EJA	01/07/20	ANDREW H. MANN C 26086
	01/07/20	4		LJA	01/07/20	C 26086
	01/07/20		IANAGEMENT			THE OF CALIFORN
	03/26/21	TR0.0	TRASH ROUTE / STAGING PLAN	ATM	10/19/21	
	01/07/20	TR0.1	TRASH ENCLOSURE PLAN	ATM	10/19/21	
	03/26/21 03/26/21	TR0.2 3	SIDE LOADER COLLECTION VEHICLE MANEUVE	R ATM	10/19/21	
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						ANDREW MANN ARCHITE 360 LANGTON STREET, SUITE 302 SAN FRANCISCO, CALIFORNIA, 94103 TELEPHONE: 415-863-4134 ANDREWMANNARCHITECTURE.COM
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	12/01/21					STRAIN AI DOVLE STREET, SUI MULLE, CALIFORNIA, TEL 510-547-2604 SIEGELSTRAIN.COM
	12/01/21					STRAIN STRAIN DOYLE STREE VILLE, CALIFO TEL 510-547-8 FAX 510-547-8 SIEGELSTRAIN
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TA TA	12/01/21					ORIGINAL SHEET ISSUE DATE:
TA	12/01/21					01/07/20
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TA	12/01/21					SHEET NUMBER:
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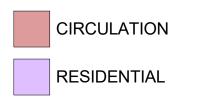


SECOND FLOOR AREA (RESIDENTIAL) -

	BUILDING			
Area Type	Gross Floor Area	Net Area (85% Gross)	Actual N	
RESIDENTIAL	2227 SF	1893 SF	S	
Total	2227 SF	1893 SF		

SECOND FLOOR AREA (NON-RESIDENTIAL) -COMMUNITY BUILDING Gross Floor Net Area (85% Area Type Area Gross) CIRCULATION 184 SF 156 SF Total 184 SF 156 SF


Floor Area Legend





FIRST FLOOR AREA (NON-RESIDENTIAL) COMMUNITY BUILDING			
Gross Floor Area	Net Area (85% Gross)	ŀ	
4158 SF	3534 SF		
1236 SF	1051 SF		
655 SF	557 SF		
538 SF	457 SF		
667 SF	567 SF		
1268 SF	1078 SF		
8522 SF	7244 SF		
	COMMUNITY Gross Floor Area 4158 SF 1236 SF 655 SF 538 SF 667 SF 1268 SF	COMMUNITY BUILDING Gross Floor Area Net Area (85% Gross) 4158 SF 3534 SF 1236 SF 1051 SF 655 SF 557 SF 538 SF 457 SF 667 SF 567 SF 1268 SF 1078 SF	

Area Type	Gross Floor Area	Net Area (85% Gross)	ŀ
ASSEMBLY	2122 SF	1803 SF	
SERVICES	848 SF	720 SF	
Total	2969 SF	2524 SF	

Floor Area Legend

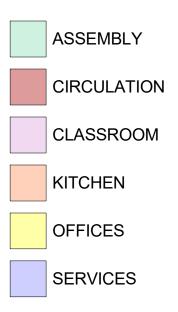

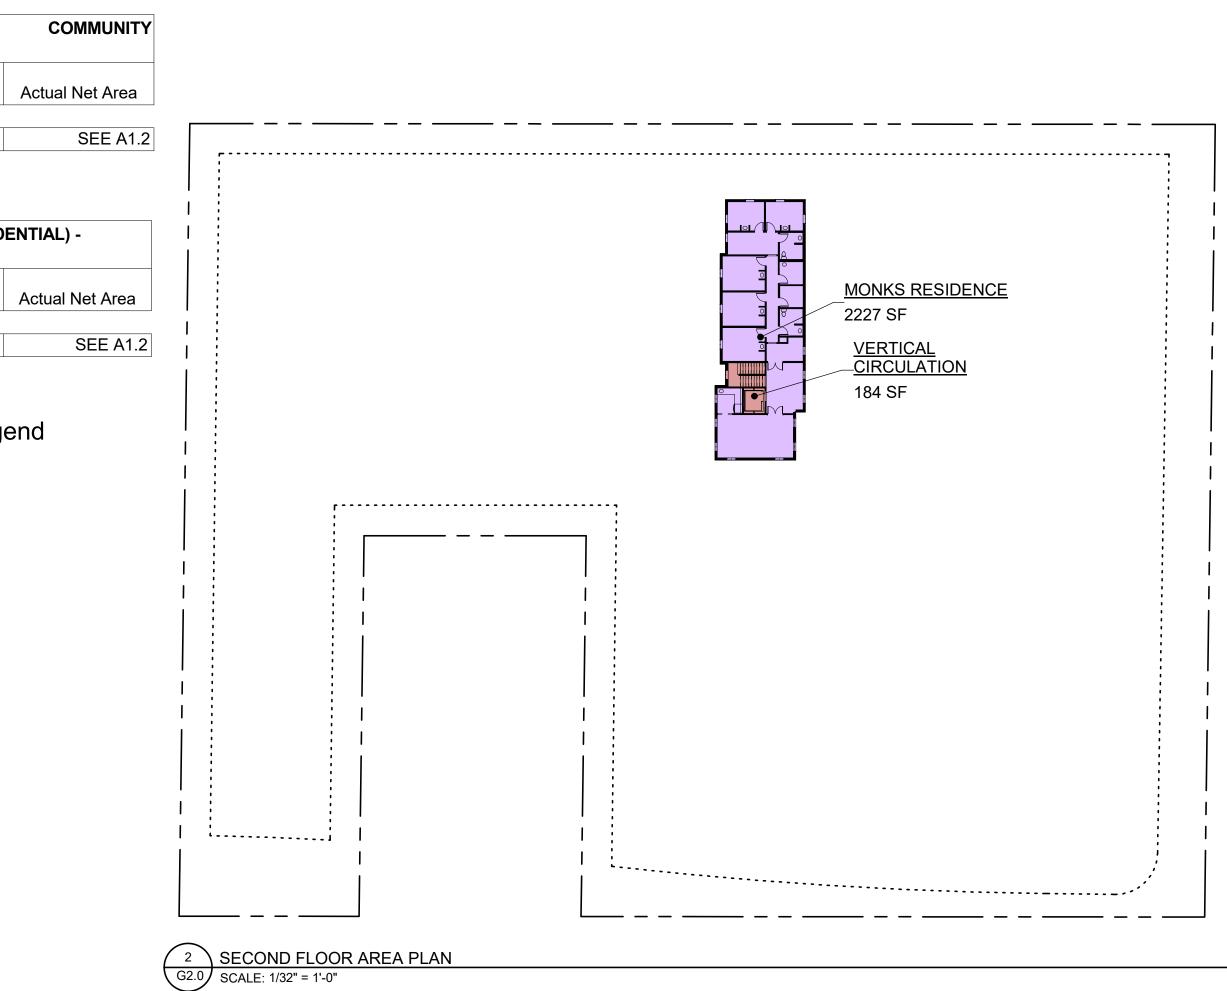

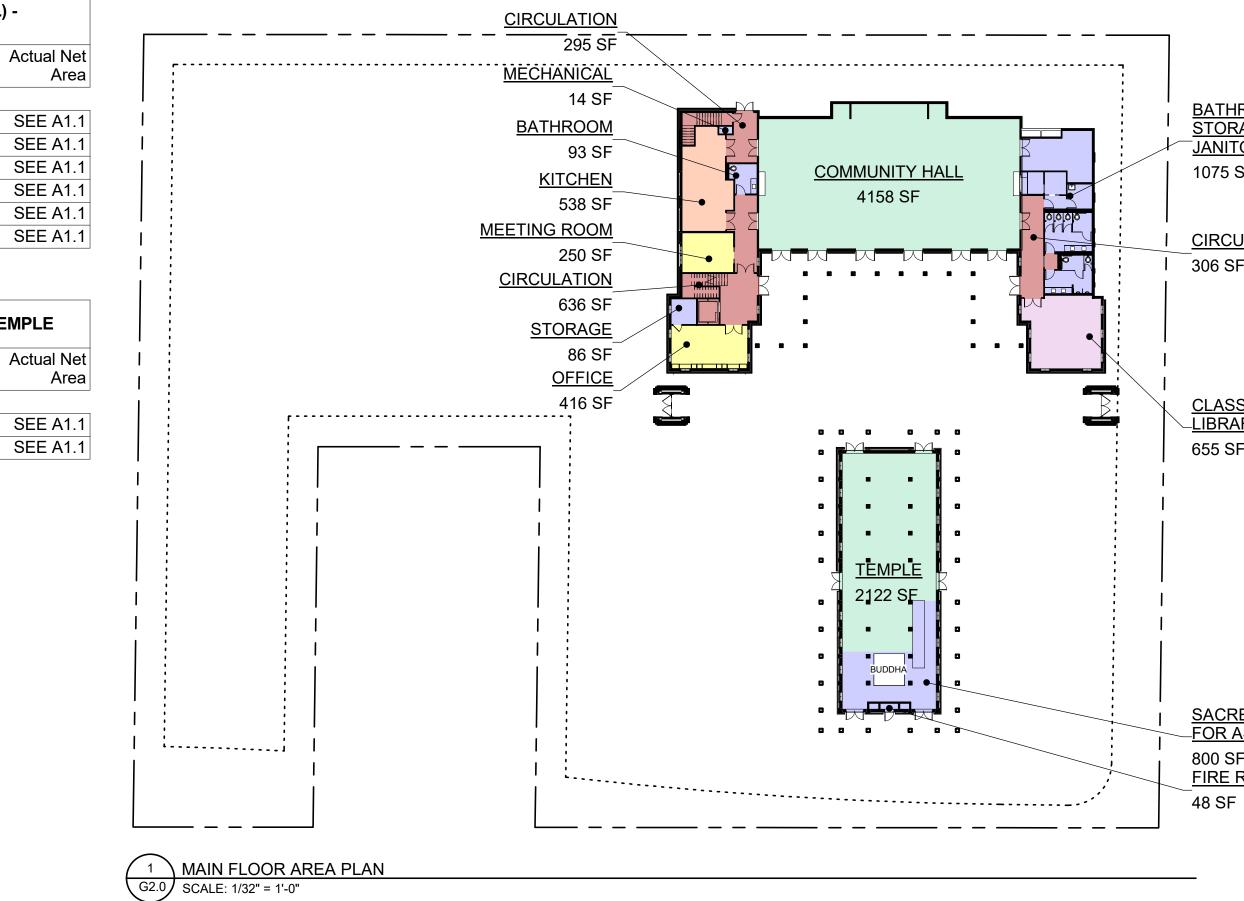

TOTAL FLOOR AREA:

NOTE: TOTAL FLOOR AREA CALCULATIONS DO NOT INCLUDE UNOCCUPIED BASEMENT AREAS AND EXTERIOR COVERED AREAS. GROSS FLOOR AREA CALCULATIONS MEASURED FROM OUTSIDE FACE OF EXTERIOR WALLS.

TOTAL FIRST FLOOR AREA				
AREA TYPE	Gross Floor Area	Net Area (85% Gross)	Actual Net Area	
NON-RESIDENTIAL - COMMUNITY BUILDING	8522 SF	7244 SF	N/A	
NON-RESIDENTIAL - TEMPLE	2969 SF	2524 SF	N/A	
RESIDENTIAL	0 SF	0 SF	N/A	
Total	11491 SF	9768 SF	N/A	

TOTAL SECOND FLOOR AREA

AREA TYPE	Gross Floor Area	Net Area (85% Gross)	Actual Net Area
RESIDENTIAL - COMMUNITY BUILDING	2227 SF	1893 SF	N/A
NON-RESIDENTIAL - COMMUNITY BUILDING	184 SF	156 SF	N/A
Total	2411 SF	2049 SF	N/A

TOTAL PROJECT FLOOR AREA (INCLUDES BOTH RESIDENTIAL & NON-RESIDENTIAL)

AREA TYPE	Gross Floor Area	Net Area (85% Gross)	Actual Net Area
FIRST FLOOR	11491 SF	9768 SF	N/A
SECOND FLOOR	2411 SF	2049 SF	N/A
Total	13902 SF	11817 SF	N/A

<u>BATHROOMS,</u> STORAGE & JANITORIAL 1075 SF


CIRCULATION 306 SF


CLASSROOM & LIBRARY 655 SF

<u>SACRED SPACE NOT</u> _<u>FOR ASSEMBLY</u> 800 SF FIRE RISER CLOSET

≥ ∕

REV ISSUED FOR DATE CUP 01/07/20 REV 1 SUP 03/26/21 REV 2 SUP 10/19/21 REV 3 SUP 02/09/22	
NOT FOR CONSTRUCTION	
ANDREW H. MANN * C 26086 REN. 3/31/23 * OF CALIFORN	
WAT KHMER KAMPUCHEA KROM 2740 RUBY AVENUE SAN JOSE, CALIFORNIA 95148 APN: 652-29-014 PROJECT FILE NO. SP20-024	
ANDREW MANN ARCHITECTURE 360 LANGTON STREET, SUITE 302 SAN FRANCISCO, CALIFORNIA, 94103 TELEPHONE: 415-863-4134 ANDREWMANNARCHITECTURE.COM	
BILLING ALLE A STRAIN Architects 6201 DOYLE STREET, SUITE B 6201 DOYLE STREET, SUITE B 7000000000000000000000000000000000000	
SHEET TITLE: AREA PLANS ORIGINAL SHEET ISSUE DATE: 01/07/20 SCALE: As indicated SHEET NUMBER: G2.0	

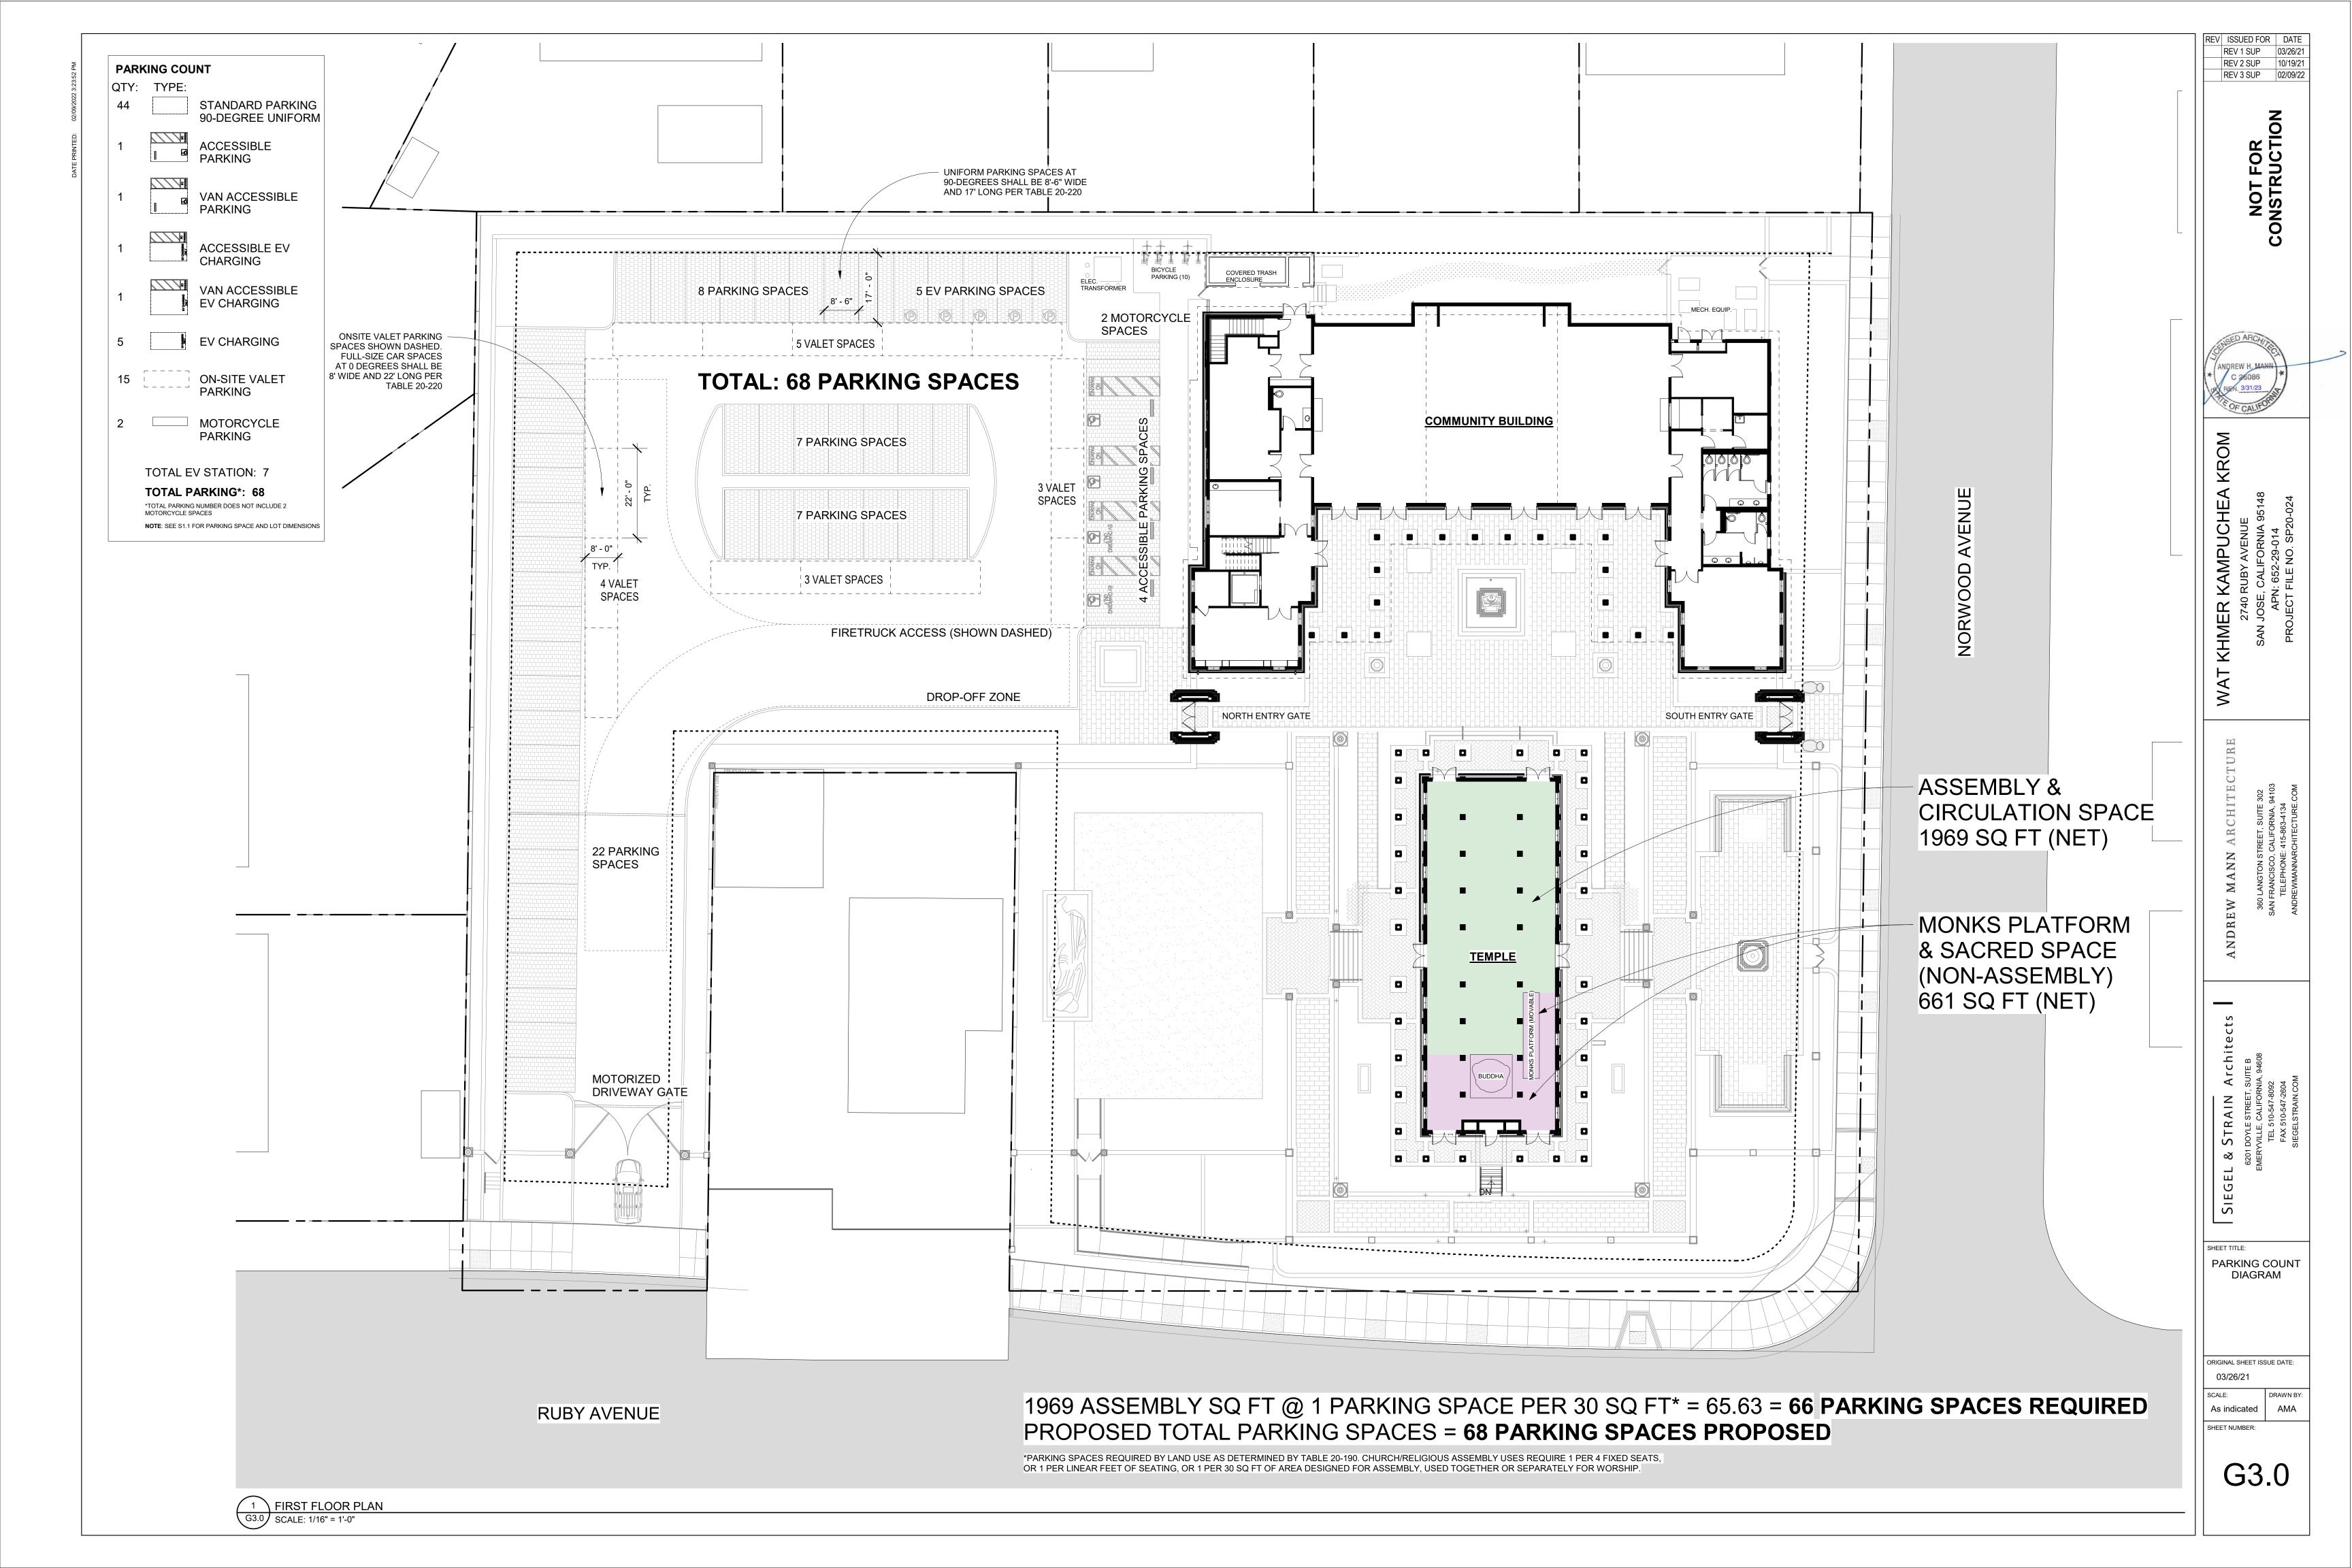

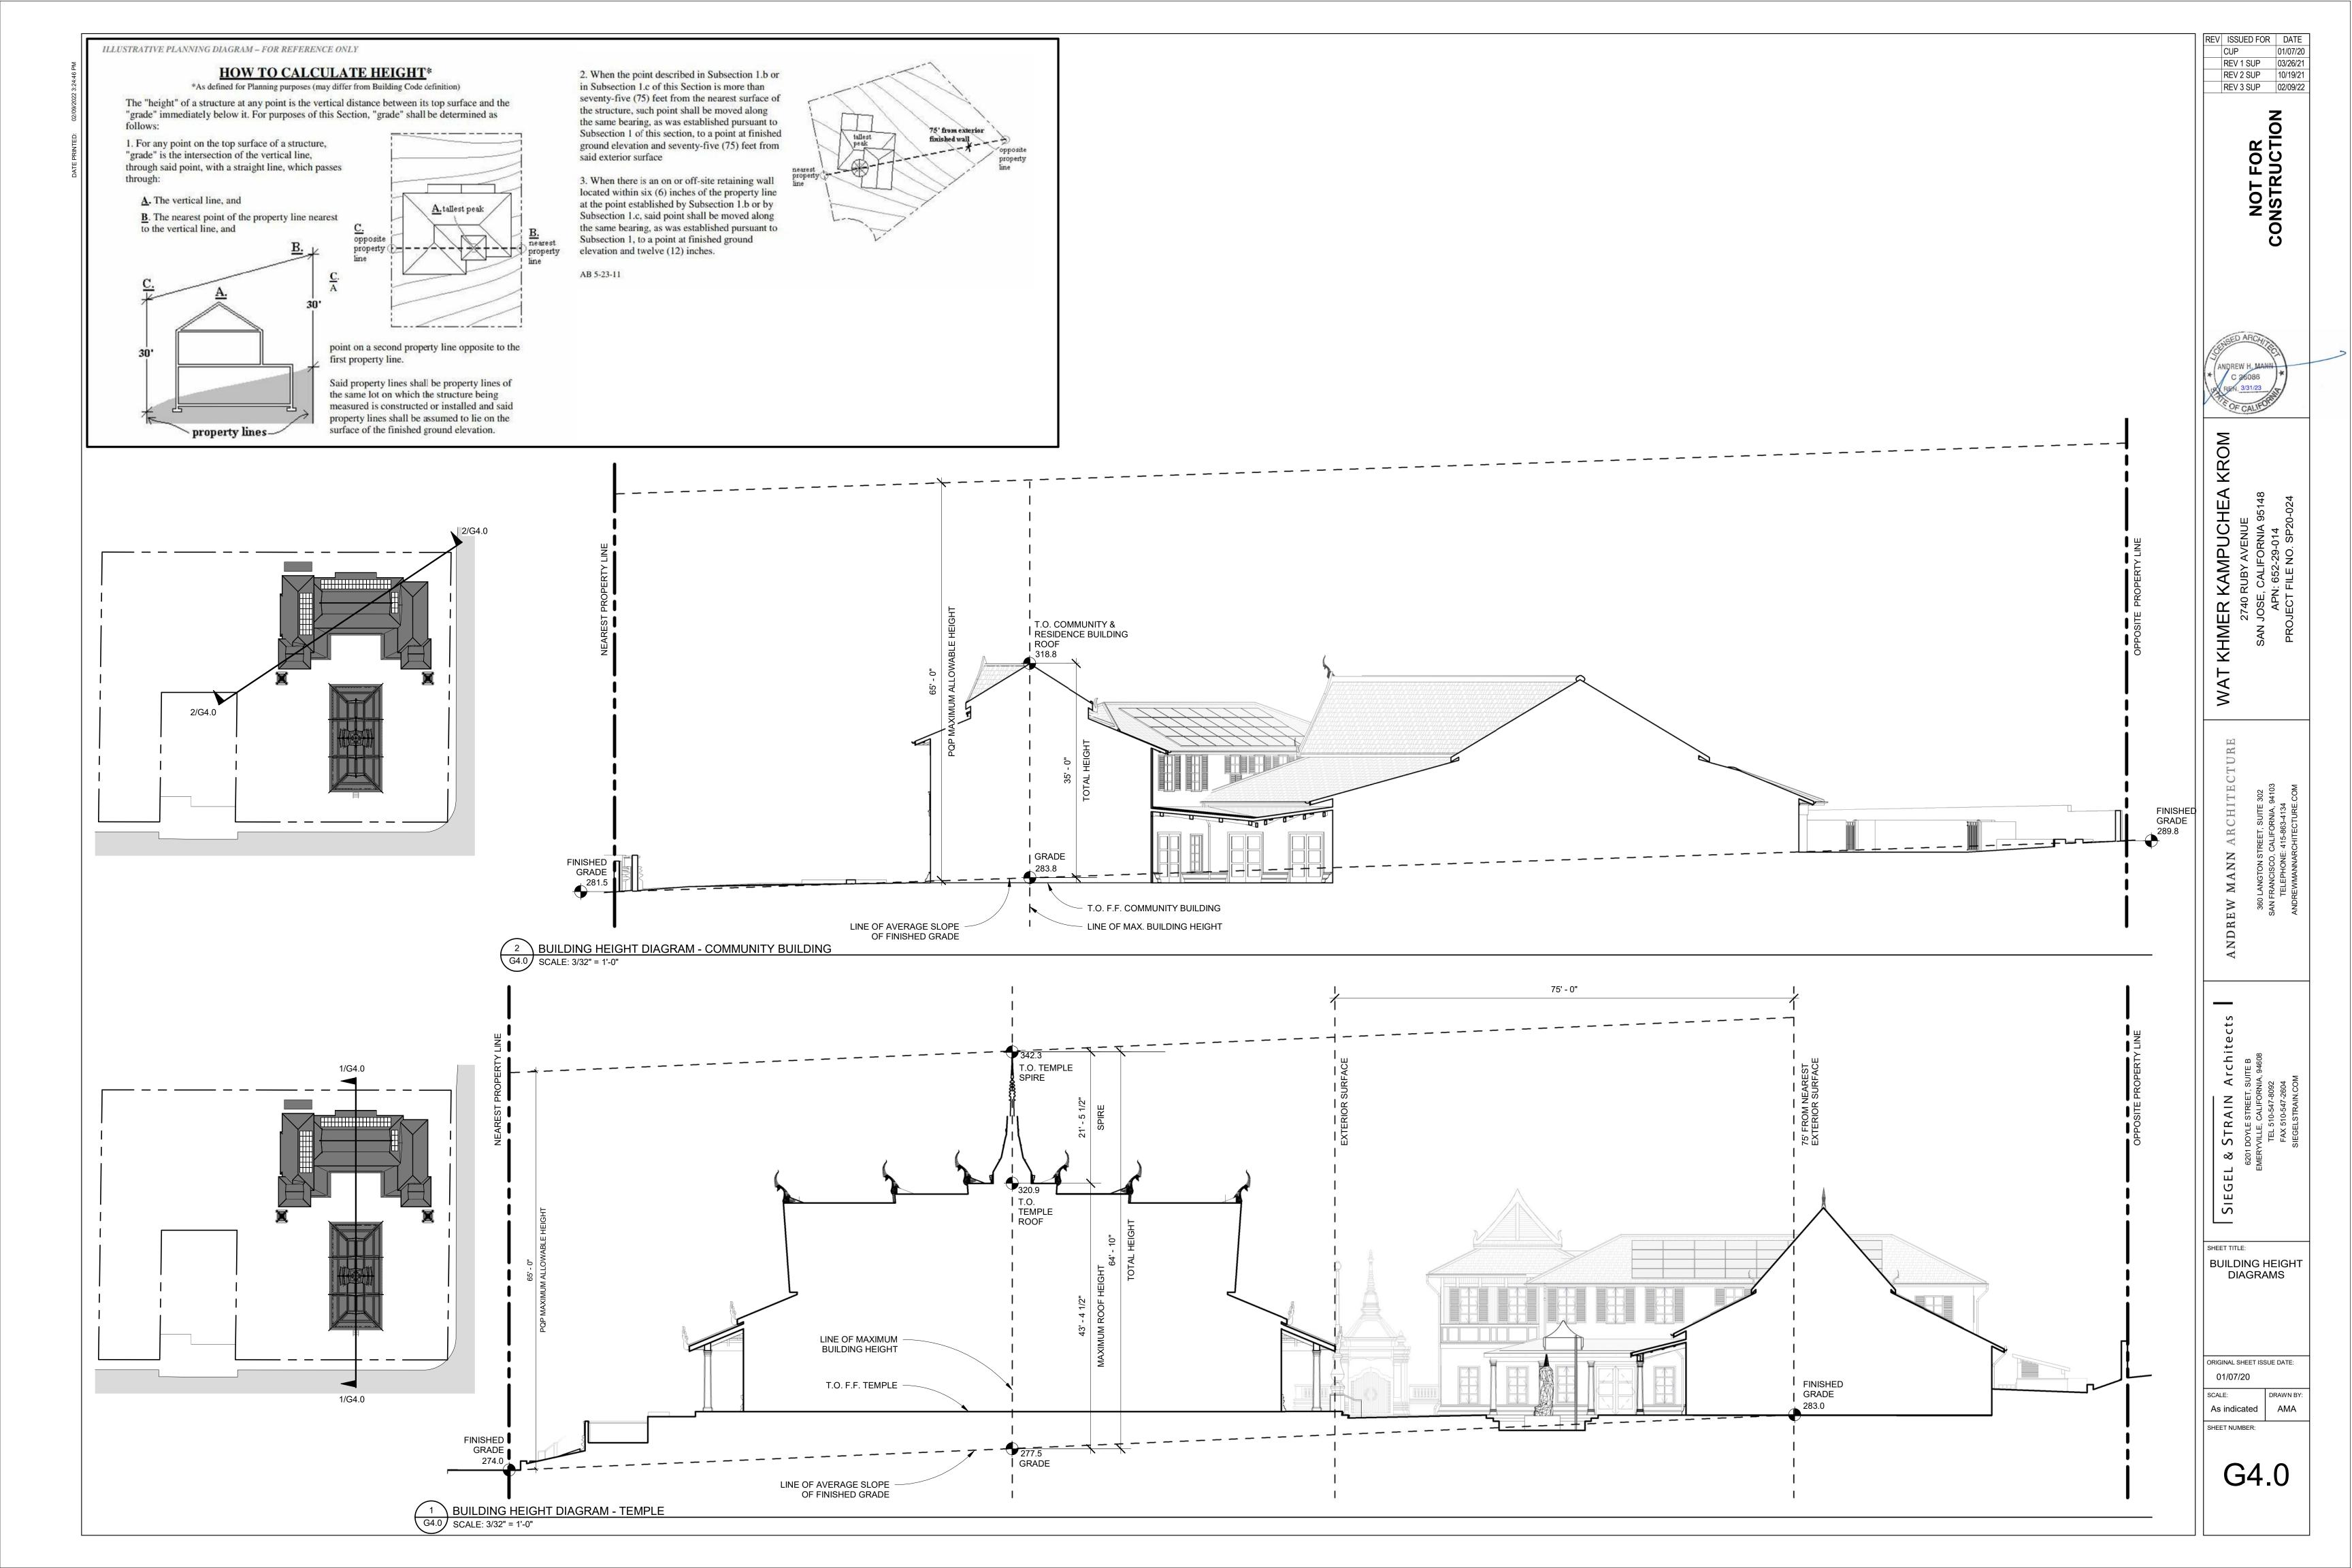

DMMUNITY BUILDING: 13,844 SF DTAL: 20,983 SF			Number	
TY OF SAN JOSE MUNICIPAL CODES AND ALL OTH			Basement 001	Ţ
IE FOLLOWING IS A SUMMARY OF THE PRIMARY B ARAPHRASED AND ARE NOT INTENDED TO BE COM		ATED TO THE PROJECT. CODE REFERENCES, WHERE PROVIDED, ARE	002	
REA AND HEIGHT LIMITATIONS BUILDING ON THE SAME LOT CONSIDERED S	EPARATE BUILDINGS	CBC 503.1.2	1st Floor	
EMPLE BUILDING:			100 102	
<u>PRIMARY OCCUPANCY</u> GROUP A3 - ASSEMBLY, 1ST FLOOR		CBC 303.4	105a	
GROUP S2 - STORAGE, BASEMENT CONSTRUCTION TYPE		CBC 311.3 CBC 602.5	106 107	-
TYPE VB			108	;
<u>RISK CATEGORY</u> III		CBC 1604.5	111 112	-
BUILDING AREA ALLOWABLE PRIMARY OCCUPANCY	18,000 SF	CBC TABLE 506.2, SM	114	
ACTUAL PRIMARY OCCUPANCY MECHANICAL BASEMENT 1ST FLOOR	1,062 SF 5,430 SF	INCLUDING OVERHANGS 4FT+	116	
	c,		2nd Floor 201	
<u>BUILDING HEIGHT AND STORIES</u> ALLOWABLE HEIGHT ACTUAL HEIGHT	60'	S, W/O AREA INCREASE, CBC TABLE 504.3	201 201a	
		LE SPIRE* CALC. AT EXTERIOR WALL PER CBC 202, GRADE PLANE	205 206	_
ALLOWABLE NUMBER OF STORIES ACTUAL NUMBER OF STORIES	2 STORIES 1 STORY	S, W/O AREA INCREASE, CBC TABLE 504.4	209	
*SPIRE EXCEPTION TO BUILDING HEIGHT PE CONSTRUCTION. IF LESS THAN 20' ,COMUST		COMBUSTABLE CONSTRUCTION. 20' LIMIT IF COMBUSTABLE WED PER CBC 1510.5	210 211	
OCCUPANCY SEPARATION BASEMENT, S-2 STORAGE	0 HR SEPARATED OCCUPA	ANCIES BETWEEN S-2 BASEMENT AND A-3 1ST FLOOR PER CBC 508.4	212	
			213	
<u>PRIMARY OCCUPANCY</u>			Grand tota	I
GROUP A-3, ASSEMBLY GROUP R-3, RESIDENTIAL		CBC 303.4 CBC 310.5		
GROUP S-2, STORAGE CONSTRUCTION TYPE		CBC 311.3 CBC 602.5		
TYPE VB			Number	
<u>RISK CATEGORY</u> III		CBC 1604.5	Basement	
<u>BUILDING AREA</u> ALLOWABLE PRIMARY OCCUPANCY	18,000 SF	CBC TABLE 506.2, SM	T001	-
ACTUAL PRIMARY OCCUPANCY MECHANICAL BASEMENT 1ST FLOOR	1,151 SF 10,271 SF	INCLUDING OVERHANGS 4FT+		
2ND FLOOR	2,411 SF		1st Floor T100	T
<u>BUILDING HEIGHT AND STORIES</u> ALLOWABLE HEIGHT ACTUAL HEIGHT	60'	S, W/O AREA INCREASE, CBC TABLE 504.3	Grand tota	
COMMUNITY BUILDING	34'-1 1/2"	CALC. AT EXTERIOR WALL PER CBC 202, GRADE PLANE	Granu tota	1
ALLOWABLE NUMBER OF STORIES ACTUAL NUMBER OF STORIES	2 STORIES 2 STORIES	S, W/O AREA INCREASE, CBC TABLE 504.4		
OCCUPANCY SEPARATION BASEMENT, S-2 STORAGE	0 HR SEPARATED OCCUPA	ANCIES BETWEEN S-2 BASEMENT AND A-3 1ST FLOOR PER CBC 508.4		
1ST FLOOR NONSEPARATED OCCUPANCIES			Number	
ALLOWABLE BUILDING AREA, HEIGH NO SEPARATION REQUIRED BETWEE				
2ND FLOOR, R-3 RESIDENTIAL	508.4.	NCIES BETWEEN A-3 1ST AND R-3 2ND FLOOR PER CBC 711.2.4.3/	01 02	-
NUMBER OF EXITS		TING 2ND FLOOR PROTECTED WITH 1 HR RATING. LATED BY OCCUPANT LOAD PER TABLE 1004.5. SEE G5.1	03	
		ED TO HAVE ONE EXIT PER CBC 1006.2.1 EX. 1 AND 1006.3.2 EX. 4. ICE TO PROVIDE EMERGENCY EGRESS PER CBC 1030.		
E-RESISTANCE FOR BUILDING ELEMENTS PRIMARY STRUCTURAL FRAME:	0	CBC TABLE 601		
EXTERIOR BEARING WALLS: INTERIOR BEARING WALLS:	0, 1 HR AT WALLS SUPPOR 0, 1 HR AT WALLS SUPPOR		ΝΟΤ	Ξ
EXTERIOR NON-BEARING WALLS: INT NON-BEARING PARTITIONS: FLOOR CONSTRUCTION:	0 0 0, 1 HR AT 2ND FLOOR ASS	SEMBLY		
ROOF CONSTRUCTION:	0 [°]		- 00	-
STAIRWAY E-RESISTANCE FOR EXT. WALLS BASED ON FIRE		AT HORIZONTAL EXIT, CBC 1023 C TABLE 602	DEP/	
LESS THAN 10FT GREATER THAN 10FT	1-HR RATING REQ, NO INS		(300)	
			ATTE	
ENING PROTECTION BASED ON FIRE SEPARATIO	N			-
ILY APPLIES TO BUILDINGS WHOSE EXTERIOR W. AME ARE REQUIRED TO BE FIRE RESISTIVE RATE		CBC 705.8.1, EX. 2	- SEE	-
<u>RE SPRINKLER SYSTEM</u> ROVIDED AT BOTH BUILDINGS AND 4FT+ OVERHAN	IGS			_
T <u>ANDPIPE SYSTEM</u> TE HYDRANT PROVIDED, SEE CIVIL DRAWINGS				
RE & SMOKE ALARM SYSTEMS	D CF	PC TABLE A, excludes mechanical rooms		
RE & SMOKE ALARM SYSTEMS				
RE & SMOKE ALARM SYSTEMS OVIDED NIMUM PLUMBING FIXTURES OCCUPANT LOA	_	CCUPANTS		
<u>RE & SMOKE ALARM SYSTEMS</u> OVIDED NIMUM PLUMBING FIXTURES OCCUPANT LOA CUPANCY AREA FACTOR COUP A-3 8,714 1/30 SF	OC 291 OC	CCUPANTS C., 146 M, 146 F		
RE & SMOKE ALARM SYSTEMS OVIDED NIMUM PLUMBING FIXTURES OCCUPANT LOA CUPANCY AREA FACTOR ROUP A-3 8,714 1/30 SF ROUP R-3 1,270 1/200 SF	OC 291 OC 7 OCC, 7			
E & SMOKE ALARM SYSTEMS OVIDED NIMUM PLUMBING FIXTURES OCCUPANT LOA CUPANCY AREA FACTOR OUP A-3 8,714 1/30 SF OUP R-3 1,270 1/200 SF TAL NIMUM PLUMBING FIXTURES	 291 OC 7 OCC, 7 387 (C., 146 M, 146 F 7 M, NO FEMALE		
E & SMOKE ALARM SYSTEMS OVIDED NIMUM PLUMBING FIXTURES OCCUPANT LOA CUPANCY AREA FACTOR OUP A-3 8,714 1/200 SF TAL NIMUM PLUMBING FIXTURES QUIRED: WATER CLOSETS MALE FEMALE	OC 291 OC 7 OCC, 7 387 (NALS LAVITORIES MALE FEMALE	C., 146 M, 146 F 7 M, NO FEMALE OCCUPANTS CPC TABLE 422.1		
E & SMOKE ALARM SYSTEMS OVIDED IIMUM PLUMBING FIXTURES OCCUPANT LOA CUPANCY AREA FACTOR OUP A-3 8,714 1/30 SF OUP R-3 1,270 1/200 SF TAL IIMUM PLUMBING FIXTURES QUIRED: WATER CLOSETS URIN MALE FEMALE OUP A-3 2 4 OUP R-3 1 0		C., 146 M, 146 F 7 M, NO FEMALE OCCUPANTS CPC TABLE 422.1 DRINKING FOUNTAINS SERVICE SINK		
E & SMOKE ALARM SYSTEMS OVIDED IMUM PLUMBING FIXTURES OCCUPANT LOA CUPANCY AREA FACTOR OUP A-3 8,714 1/30 SF OUP R-3 1,270 1/200 SF TAL IMUM PLUMBING FIXTURES QUIRED: WATER CLOSETS URIN MALE FEMALE OUP A-3 2 4 OUP R-3 1 0 OVIDED PLUMBING FIXTURES WATER CLOSETS URIN		C., 146 M, 146 F 7 M, NO FEMALE DCCUPANTS CPC TABLE 422.1 DRINKING FOUNTAINS SERVICE SINK 2 1 1 1 DRINKING FOUNTAINS SERVICE SINK		
E & SMOKE ALARM SYSTEMS OVIDED MIMUM PLUMBING FIXTURES OCCUPANT LOA CUPANCY AREA FACTOR OUP A-3 8,714 1/30 SF OUP R-3 1,270 1/200 SF TAL MIMUM PLUMBING FIXTURES QUIRED: WATER CLOSETS URIN MALE FEMALE OUP A-3 2 4 OUP R-3 1 0 OVIDED PLUMBING FIXTURES WATER CLOSETS URIN MALE FEMALE UNISEX	OC 291 OC 7 OCC, 7 387 C NALS LAVITORIES <u>MALE FEMALE</u> 2 1 2 1 1 0	C., 146 M, 146 F 7 M, NO FEMALE DCCUPANTS CPC TABLE 422.1 DRINKING FOUNTAINS SERVICE SINK 2 1 1 1 DRINKING FOUNTAINS SERVICE SINK		
RE & SMOKE ALARM SYSTEMS ROVIDED NIMUM PLUMBING FIXTURES OCCUPANT LOA CCUPANCY AREA FACTOR ROUP A-3 8,714 1/30 SF ROUP R-3 1,270 1/200 SF DTAL NIMUM PLUMBING FIXTURES URIN MIMUM PLUMBING FIXTURES URIN ROUP A-3 2 4 NIMUM PLUMBING FIXTURES URIN MALE FEMALE ROUP A-3 1 0 ROUP R-3 1 0	VALS LAVITORIES MALE FEMALE 2 1 2 1 1 0 NALS LAVITORIES MALE FEMALE UNISE	C., 146 M, 146 F 7 M, NO FEMALE DCCUPANTS CPC TABLE 422.1 DRINKING FOUNTAINS SERVICE SINK 2 1 1 1 DRINKING FOUNTAINS SERVICE SINK EX		

Со	mmunity Buil	ding Occupant Load		
Name	Net Area	Occupancy	Occupant Factor	Occupant Load
MECH. /ELEC.	868 SF	Mechanical Equipment Room	300 SF	3
MACHINE ROOM	54 SF	Mechanical Equipment Room		1
	922 SF			4
COMMUNITY HALL	3948 SF	Assembly Concentrated	5 SF	790
CLASSROOM /LIBRARY	586 SF	Classroom Area	20 SF	30
COAT ROOM	54 SF	Accessory Storage Area	300 SF	1
JANITORIAL	68 SF	Accessory Storage Area	300 SF	1
A/V	54 SF	Accessory Storage Area	300 SF	1
STORAGE	312 SF	Accessory Storage Area	300 SF	2
OFFICE	364 SF	Business Area	150 SF	3
CLO.	70 SF	Accessory Storage Area	300 SF	1
MEETING ROOM	224 SF	Business Area	150 SF	2
KITCHEN	493 SF	Kitchen	200 SF	3
	6174 SF			832
LIVING ROOM	364 SF	Residential	200 SF	2
KITCHENETTE	70 SF	Residential	200 SF	1
CLOSET	56 SF	Residential	200 SF	1
LAUNDRY	60 SF	Residential	200 SF	1
BEDROOM 1	119 SF	Residential	200 SF	1
BEDROOM 2	116 SF	Residential	200 SF	1
BEDROOM 3	161 SF	Residential	200 SF	1
BEDROOM 4	159 SF	Residential	200 SF	1
BEDROOM 5	157 SF	Residential	200 SF	1
	1262 SF			11
	8358 SF			847

Temple Building Occupant Load

Name	Area	Occupancy	Occupant Factor	Occupant Load
TEMPLE UTILITY BASEMENT	1329 SF	Mechanical Equipment Room	300 SF	5
	1329 SF	- I		5
TEMPLE	2630 SF	Assembly Concentrated	5 SF	526
	2630 SF			526
	3959 SF			531

Courtyard Occupant Load				
Name	Area	Occupancy	Occupant Factor	Occupant Load
Courtyard 1	4385 SF	Assembly Concentrated	5 SF	878
Courtyard 2	3225 SF	Assembly Concentrated	5 SF	646
Courtyard 3	1664 SF	Assembly Concentrated	5 SF	333
				1856

S:

CUPANT LOADS PROVIDED SOLELY FOR BUILDING ARTMENT EGRESS ANALYSIS PER CBC TABLE 1004.5 DO <u>NOT</u> ACCOUNT FOR MAXIMUM SITE OCCUPANCY NOR REPRESENT ACTUAL EXPECTED BUILDING NDANCE.


G5.1 FOR EGRESS ANALYSIS


LEGEND


CODE LEGEND SCALE: 1/16" = 1'-0"

_ _ _ _ _ _ _ 1-HR FIRE-RATED WALL


ASSUMED PROPERTY LINE

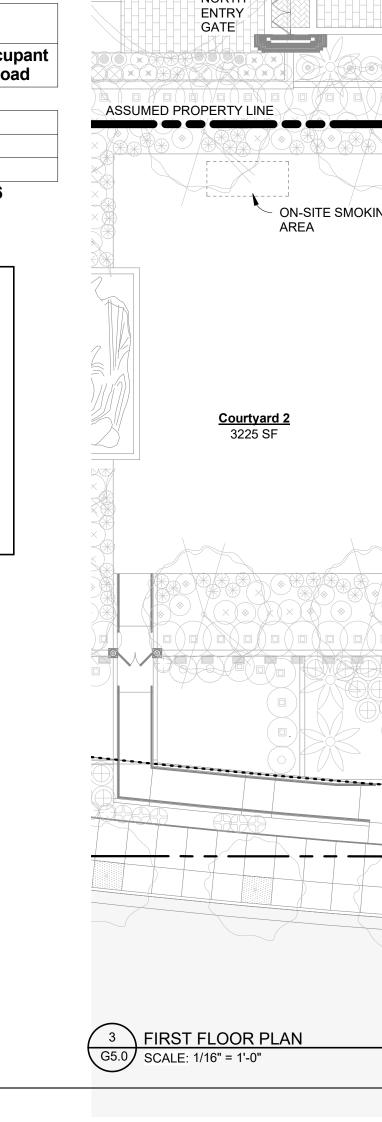

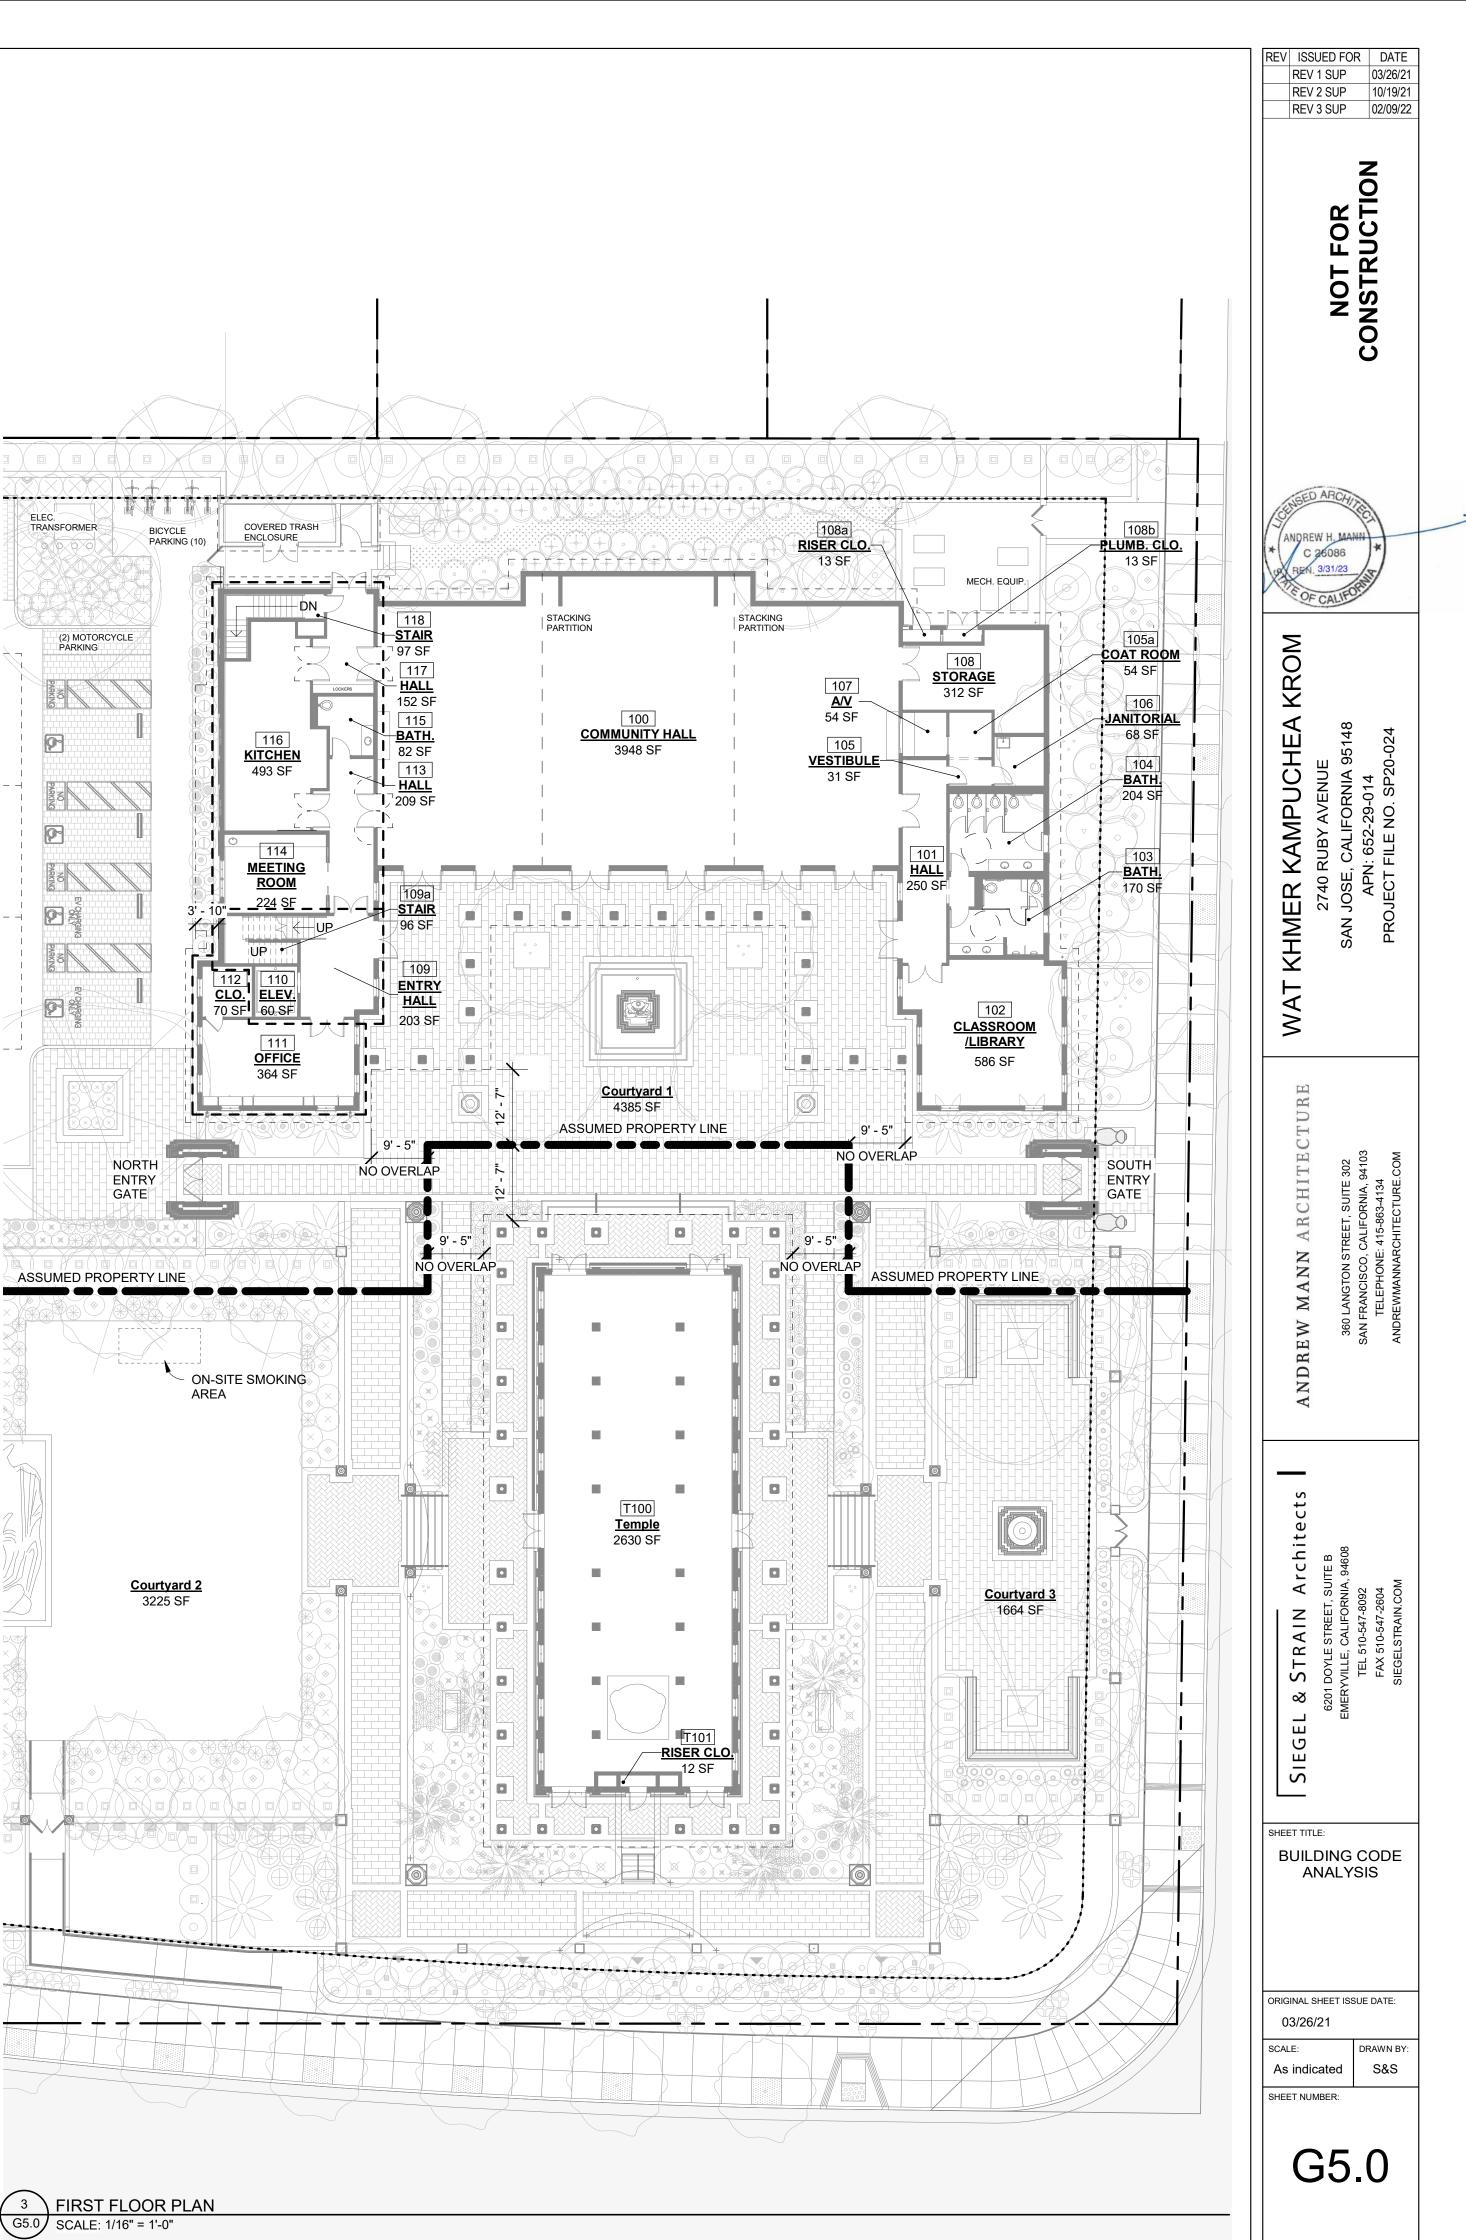

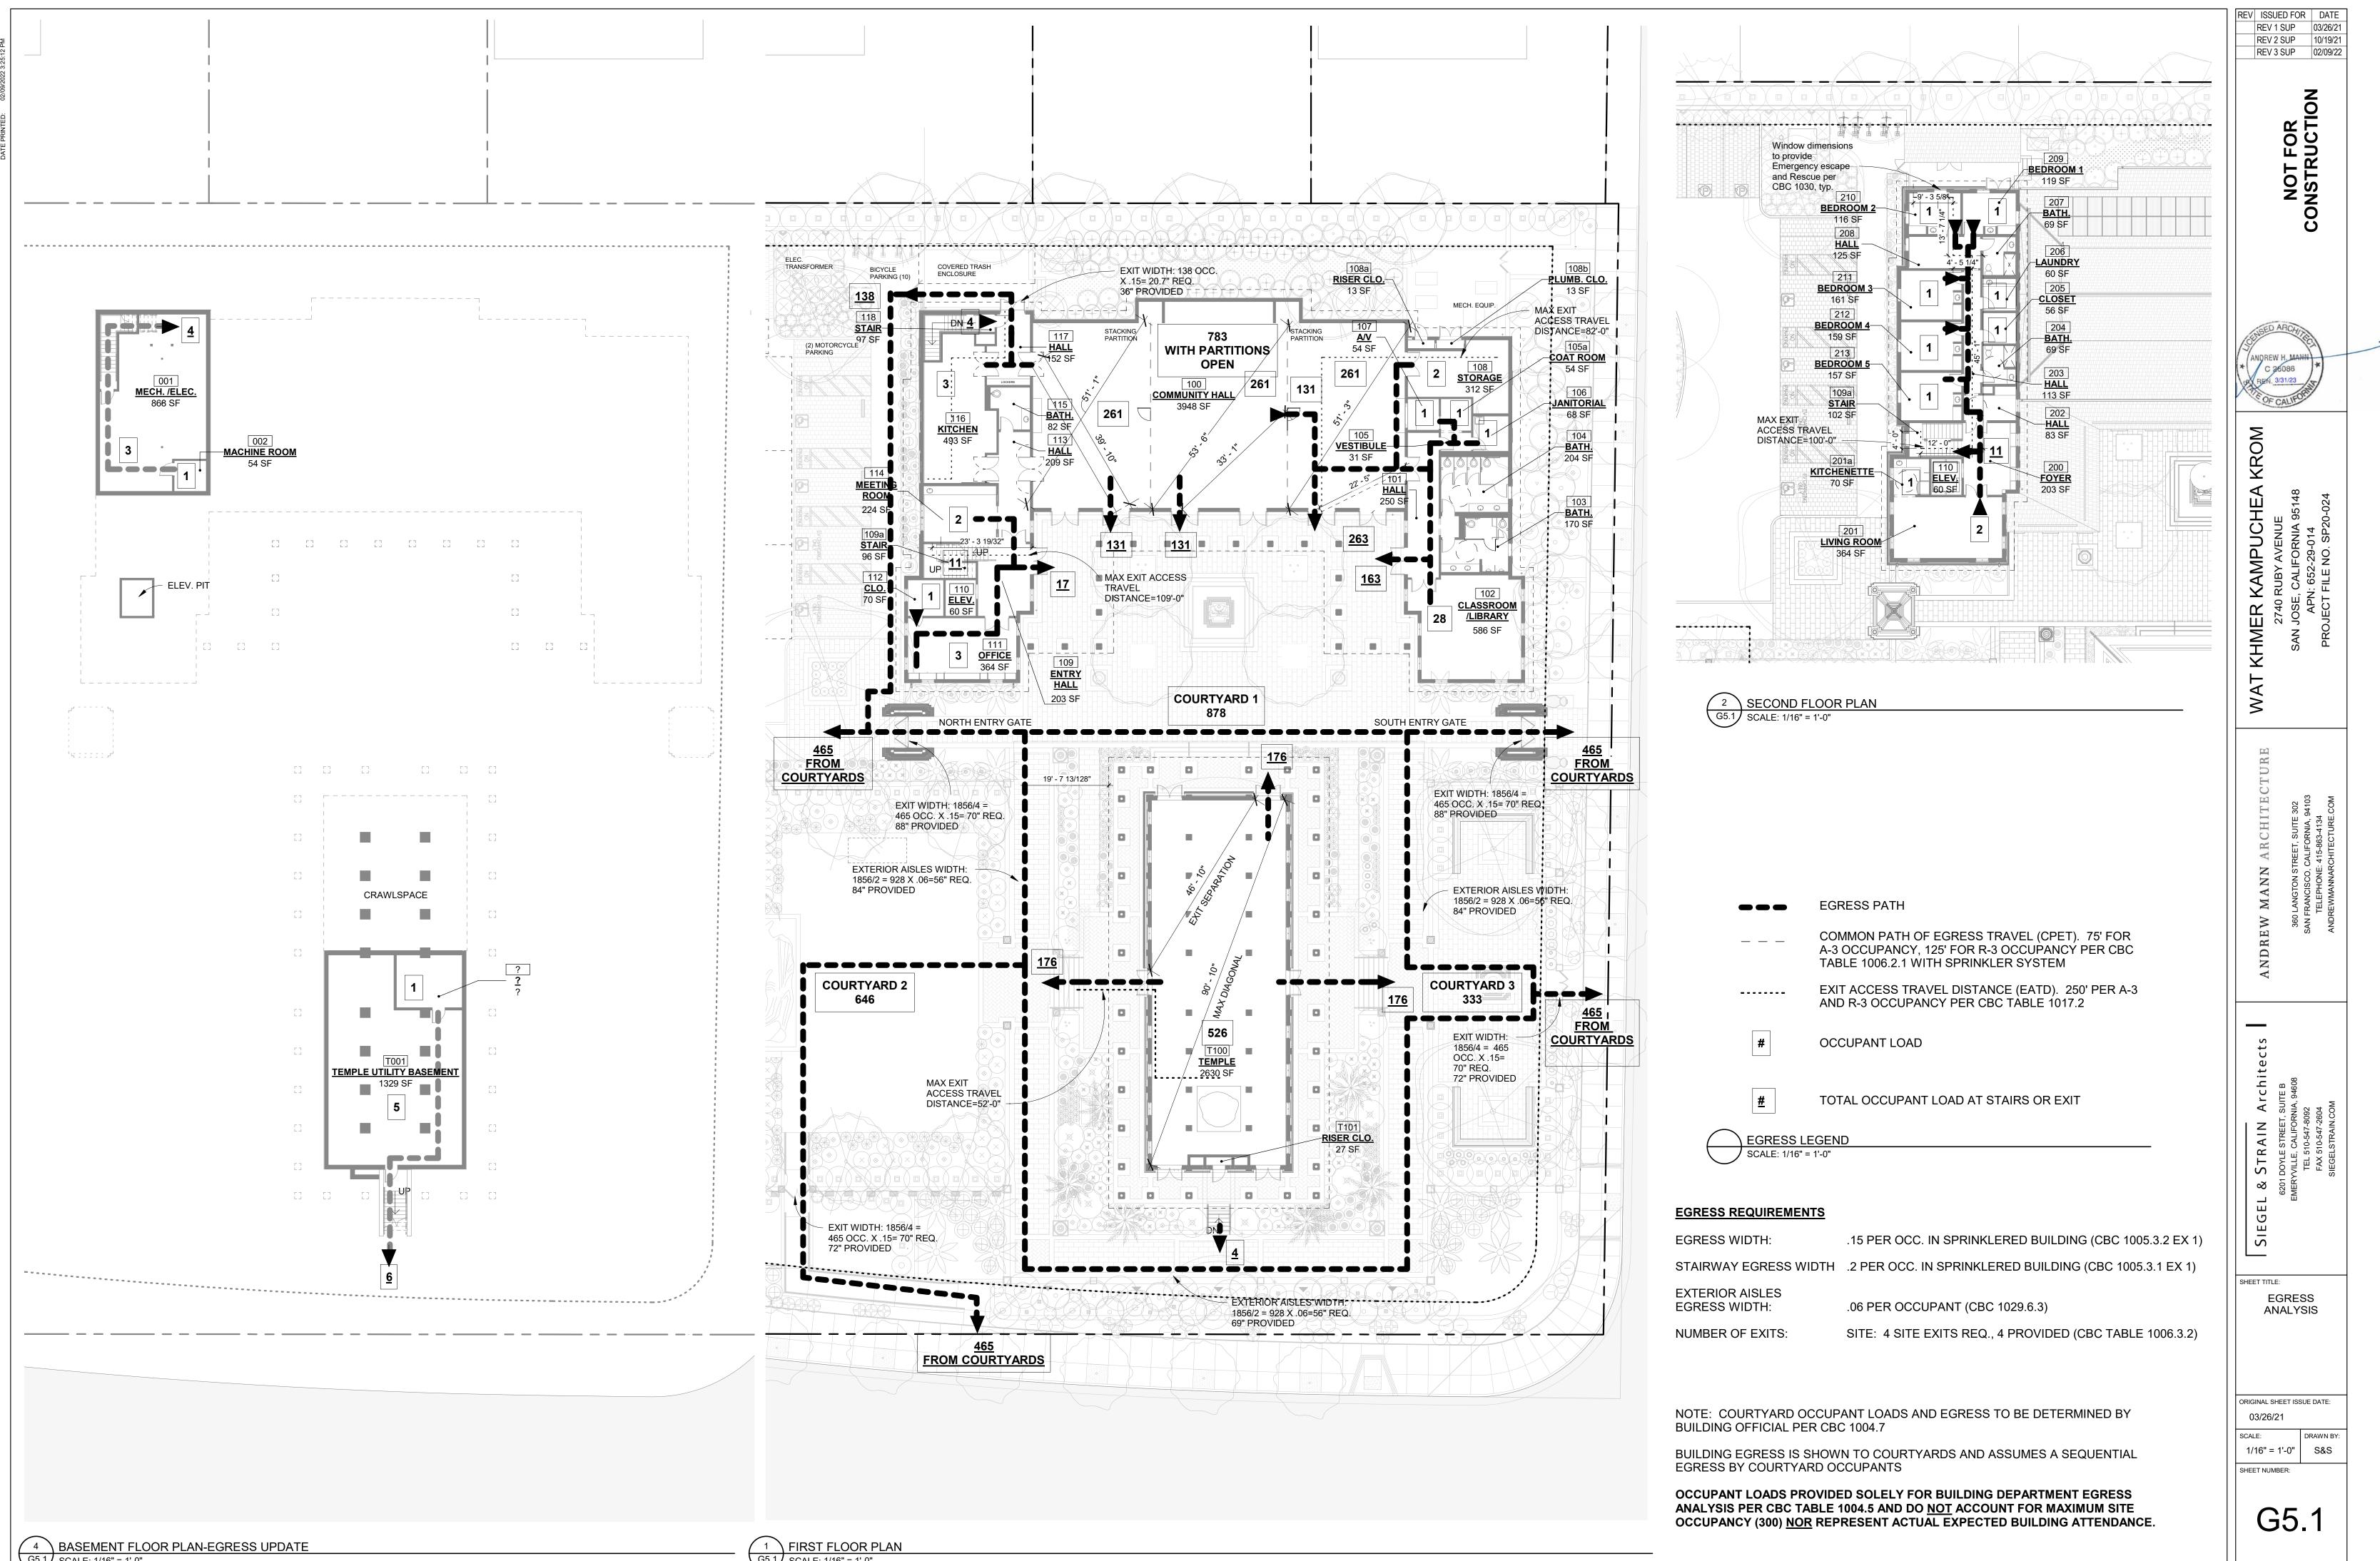

G5.1 SCALE: 1/16" = 1'-0"

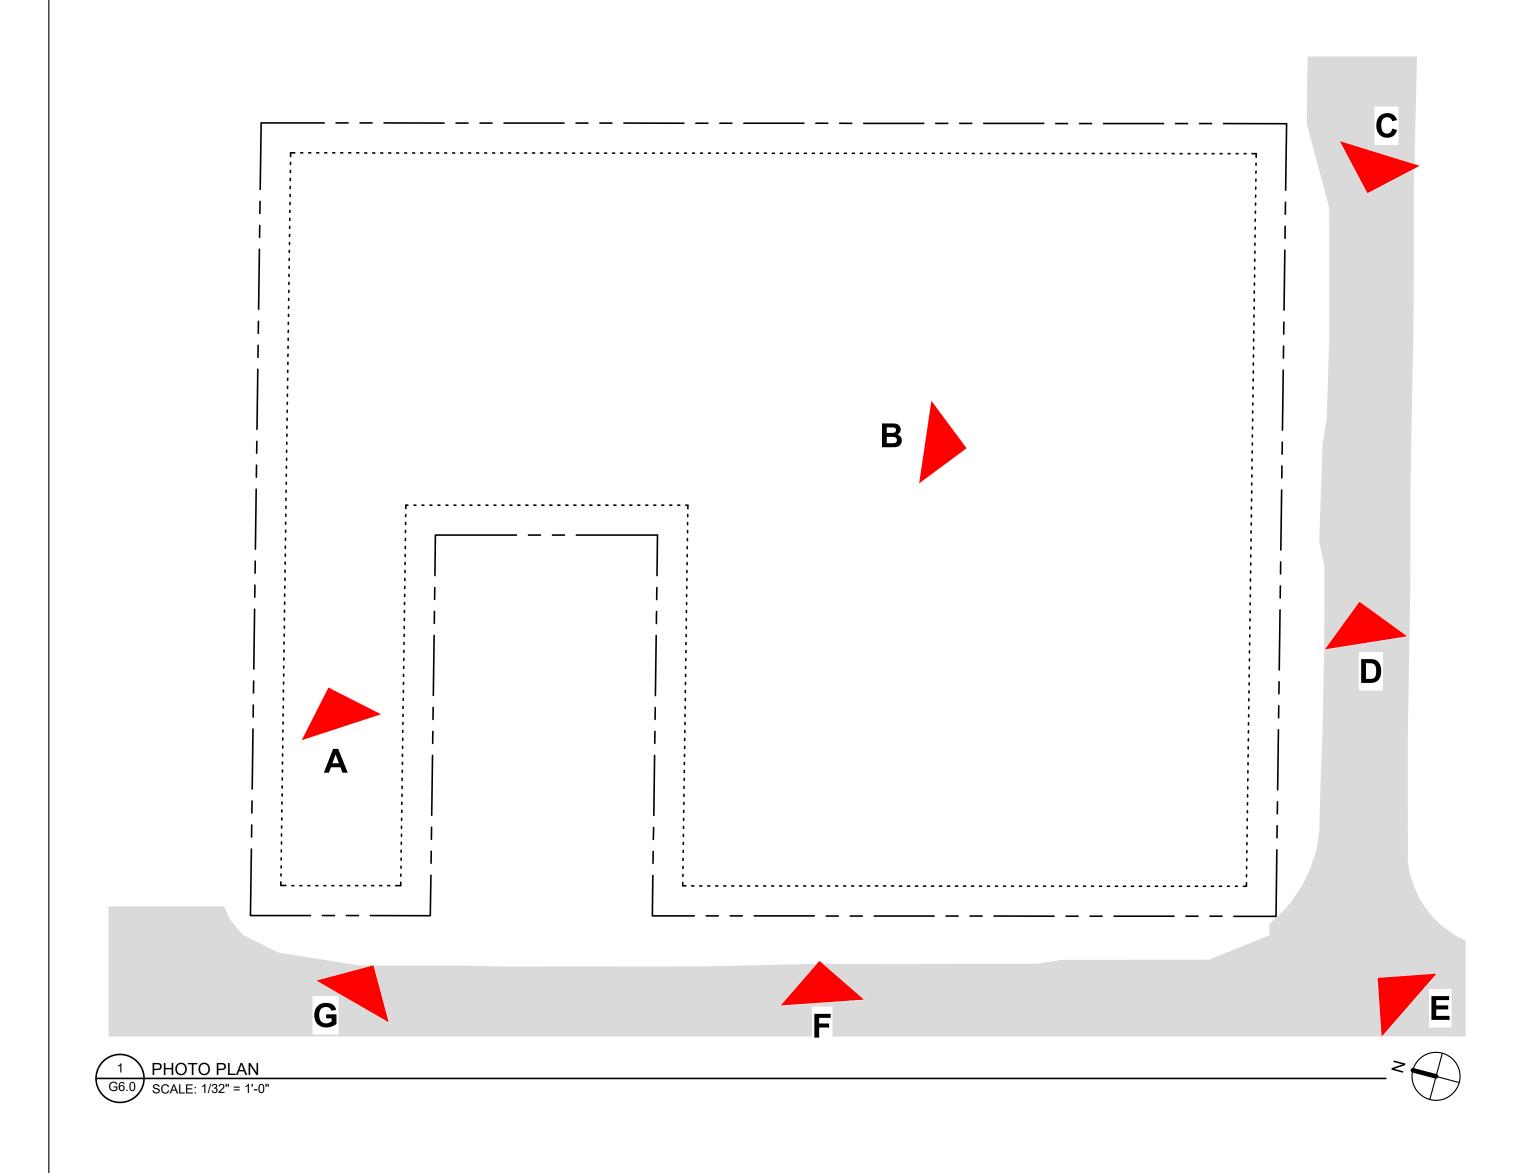



E: VIEW FROM INTERSECTION




A: VIEW N.E. FROM RUBY AVE



C: VIEW W. ALONG NORWOOD AVE.



F: VIEW E. ALONG RUBY AVE.

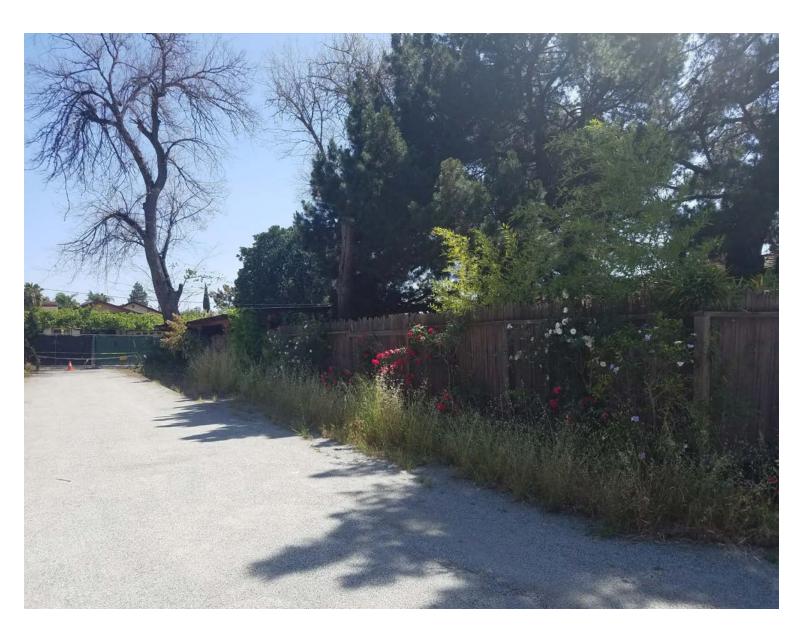

B: VIEW S.E. TOWARDS NORWOOD AVE




D: VIEW E. ALONG NORWOOD AVE.



G: VIEW E. ALONG RUBY AVE.

REV ISSUED FOR DATE CUP 01/07/20 REV 1 SUP 03/26/21 REV 2 SUP 10/19/21 REV 3 SUP 02/09/22	
WAT KHMER KAMPUCHEA KROM 2740 RUBY AVENUE SAN JOSE, CALIFORNIA 95148 APN: 652-29-014 PROJECT FILE NO. SP20-024	
ANDREW MANN ARCHITECTURE	
SIEGEL & STRAIN Architects 6201 DOYLE STREET, SUITE B EMERVILLE, CALIFORNIA, 94608 TEL 510-547-8092 FAX 510-547-2604 SIEGELSTRAIN.COM	
SITE PHOTOS	



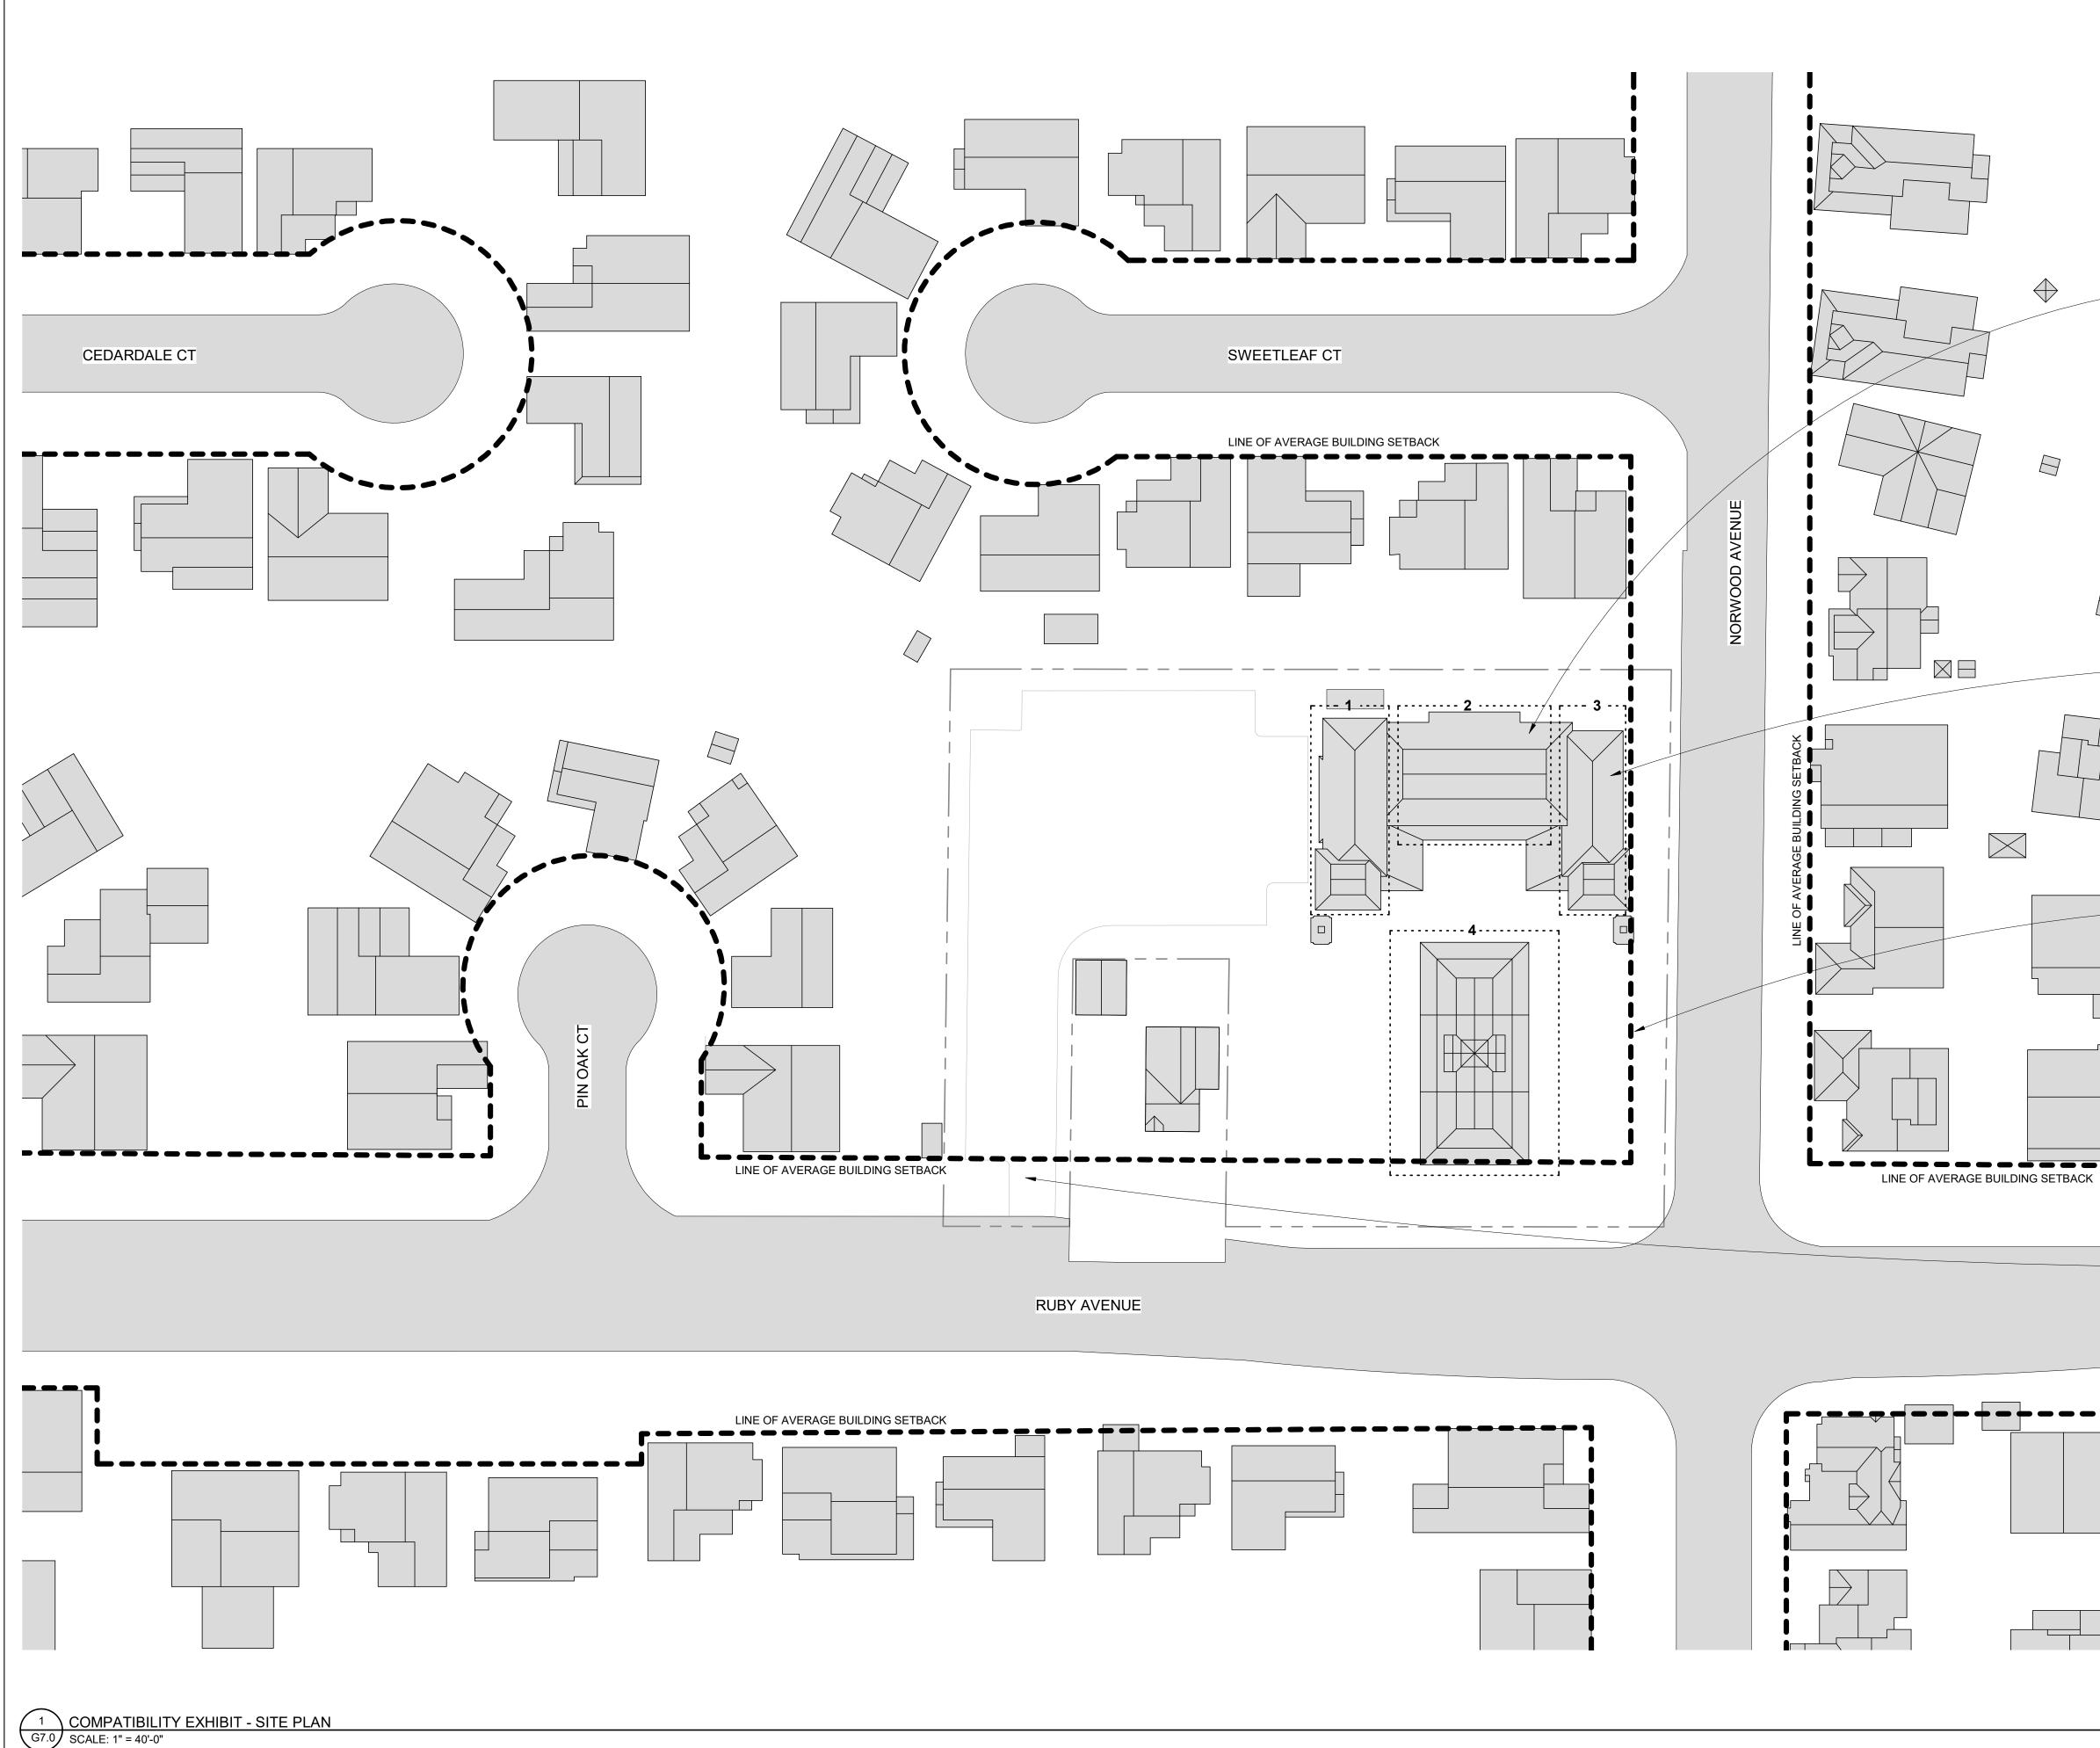

BUILDING FORM, SCALE & ORIENTATION:

- BUILDING FORMS FOUND IN THE SURROUNDING DEVELOPMENT AND PROPOSED TEMPLE PROJECT ARE GENERALLY RECTILINEAR.

- SURROUNDING HOMES ARE VARIED IN SCALE WITH **BUILDING FOOTPRINTS RANGING FROM** APPROXIMATELY 1500-3500 SQUARE FEET. THE PROPOSED TEMPLE PROJECT INCLUDES STRUCTURES WITH BUILDING FOOTPRINTS THAT ARE INTENTIONALLY SUBDIVIDED INTO 4 SMALLER VOLUMES RANGING FROM APPROXIMATELY 2600-7200 SQUARE FEET TO ALIGN MORE CLOSELY WITH THE SCALE OF NEARBY DEVELOPMENT.

- BOTH THE SURROUNDING HOMES AND THE PROPOSED TEMPLE PROJECT INCLUDE STRUCTURES WHICH ARE TYPICALLY ORIENTED TO ALIGN ORTHAGONALLY WITH STREET FRONTAGE.

ROOF FORMS:

- SURROUNDING HOMES AND THE PROPOSED TEMPLE PROJECT EXHIBIT NEARLY EXCLUSIVELY PITCHED ROOFS OF VARIOUS PITCHES WITH COMBINATION OF GABLE AND HIPPED ROOF TYPES.

- A VARIETY OF ROOF SCALE IS FOUND IN SURROUNDING DEVELOPMENT AND THE PROPOSED PROJECT, INCLUDING LARGER PRIMARY ROOFS WITH SMALLER ACCENT GABLES AND DORMERS.

- STREET FRONTAGE & FRONT SETBACK:

- THE FRONT SETBACK OF THE SURROUNDING HOMES IS TYPICALLY 20+ FEET. THE PROPOSED TEMPLE AND COMMUNITY BUILDINGS MAINTAIN THE RESIDENTIAL BUILDING FRONT SETBACK MINIMUM OF 20 FEET FROM THE EXISTING PROPERTY LINE.

- ADDITIONAL BUILDING SETBACK IS TYPICAL ALONG THE RUBY AVENUE STREET FRONTAGE OF NEARBY HOMES. THE PROPOSED TEMPLE PROJECT PROVIDES ADDITIONAL BUILDING SETBACK AT RUBY AVENUE TO ALIGN MORE CLOSELY WITH NEARBY HOMES.


- FRONT YARDS OF BOTH THE SURROUNDING HOMES AND THE PROPOSED TEMPLE PROJECT HAVE PLANTED GROUNDCOVERING AND LANDSCAPING WITH MATURE TREES.

- VEHICULAR ENTRY AND PARKING:

- NEARBY HOMES AND INSTITUTIONAL DEVELOPMENTS WITH LOW TO MODERATE OCCUPANT CAPACITY TYPICALLY INCLUDE ONE DRIVEWAY AND SURFACE PARKING. THE PROPOSED TEMPLE PROJECT ALSO PROVIDES ONE DRIVEWAY WITH SURFACE PARKING.

- BOTH SURROUNDING DEVELOPMENTS AND THE TEMPLE PROJECT PROVIDE PAVED DRIVEWAY SURFACES.

RE\ RE\	SUED FOR / 1 SUP / 2 SUP / 3 SUP	DATE 03/26/21 10/19/21 02/09/22	
ANDRI ANDRI	EW H. MANN 26086 3/31/23	A A	
WAT KHMER KAMPUCHEA KROM	E 95148	APN: 652-29-014 PROJECT FILE NO. SP20-024	
ANDREW MANN ARCHITECTURE	360 LANGTON STREET, SUITE 302 SAN FRANCISCO, CAI IFORNIA, 94103	TELEPHONE: 415-863-4134 ANDREWMANNARCHITECTURE.COM	
SIEGEL & STRAIN Architects		S	
ORIGINAL 03/26 SCALE: 1" = 4 SHEET NU	0'-0"	S E DATE: RAWN BY: AMA	

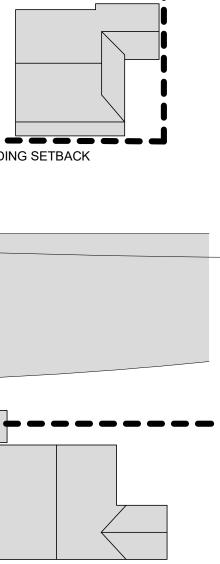

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(ABOVE) PROPOSED KITCHEN, OFFICE/MEETING, & MONK'S RESIDENCE AS VIEWED FROM SURFACE PARKING LOT









(ABOVE) NEARBY RESIDENTIAL DEVELOPMENT

COMPATIBILITY EXHIBIT: BUILDING ELEMENTS & MATERIALS

THE PROPOSED TEMPLE PROJECT INCLUDES THE FOLLOWING BUILDING ELEMENTS AND MATERIALS WHICH APPEAR IN THE SURROUNDING DEVELOPMENT, INCLUDING RESIDENTIAL HOMES AND NEARBY ASSEMBLY USES. REFER TO PHOTOGRAPHS AND PROPOSED RENDERINGS ABOVE FOR VISUAL CONFIRMATION OF COMMON BUILDING ELEMENTS 1-7.

- **EXTERIOR WALLS:** OFF-WHITE STUCCO AND VERTICAL WOOD SIDING. NEARBY DEVELOPMENT EXHIBITS A RANGE OF EXTERIOR SIDING MATERIALS SUCH AS STUCCO, VERTICAL OR HORIZONTAL SIDING, WOOD SHINGLE, BOARD BATTEN, AND BRICK.COLORS ARE OFTEN NEUTRAL, NATURAL, OR FINISHED IN A MUTED COLOR.
- **COVERED PORCHES:** COVERED PORCHES UTILIZING ROOF 5. OVERHANG AND SUPPORTED BY PLASTER AND CARVED STONE COLUMNS SIMILAR IN COLOR TO THE EXTERIOR WALLS AND TRIM. NEARBY HOMES OFTEN HAVE COVERED PORCHES •
 - SUPPORTED BY THE HOME'S STRUCTURE OR COLUMNS. A NEARBY CHURCH INCLUDES LONG COVERED PORCHES ALONG THE LENGTH OF ITS TWO STRUCTURES ON SITE. THE PORCHES UTILIZE THE ROOF OVERHANG ABOVE AND ARE SUPPORTED BY A SERIES OF COLUMNS WHICH ARE SIMILAR IN COLOR TO THE EXTERIOR WALLS.
- WINDOWS AND DOORS: PAINTED WOOD WINDOWS AND DOORS WITH 2. DIVIDED LITES, WOOD SHUTTERS. NEARBY DEVELOPMENT TYPICALLY EXHIBITS PAINTED WOOD WINDOWS, SOME OF WHICH INCLUDE DIVIDED LITES AND/OR SHUTTERS.
- LANDSCAPING ELEMENTS: LANDSCAPING ELEMENTS INCLUDE 6. GARDEN SPACES ALONG RUBY AND NORWOOD AVENUE FRONTAGES, MATURE TREES RANGING IN HEIGHT, STREET TREES, AND A VARIETY OF PLANTS. TREES AND PLANTS ARE UTILIZED AT THE SIDE AND REAR PROPERTY LINES AS A METHOD OF SCREENING THE PROPERTY.
 - NEARBY DEVELOPMENT IS TYPICALLY COMPOSED OF LANDSCAPED FRONT YARDS WITH A VARIETY OF PLANTS AND MATURE TREES. STREET TREES ARE OFTEN LOCATED AT NEARBY ASSEMBLY AND OTHER NON-RESIDENTIAL DEVELOPMENT.



(ABOVE) PROPOSED TEMPLE AS VIEWED FROM NORWOOD AVENUE











ROOF MATERIAL: GREY CERAMIC ROOF TILES WITH COLORED RED AND 3 GREEN ACCENT TILES. PAINTED EAVES. SURROUNDING DEVELOPMENT INCLUDES ALMOST EXCLUSIVELY CLAY TILE ROOFS. THE ROOFS ARE FOUND IN A RANGE OF GREY AND TERRACOTTA COLORS WITH SOME HOMES EXHIBITING BRIGHTER, RED ROOF TILES. EAVES MAY MATCH THE ROOF

MATERIAL AND ARE SOMETIME PAINTED AN ACCENT COLOR.

- 5. SITE WALLS: NEUTRAL STUCCO AND CAST STONE WALLS. LONGER SITE WALLS ARE VISUALLY DIVIDED INTO SMALLER SECTIONS AND ARE PROVIDED AS SCREENING FOR THE PROPERTY AND AS BARRIERS BETWEEN ADJACENT STREET TRAFFIC. SITE WALLS AT NEARBY HOMES ARE OFTEN MASONRY OR • PAINTED STUCCO. WALLS ARE SOMETIMES SOLID AND SOMETIMES EXHIBIT TEXTURAL OR CARVED SURFACES AND ARE OFTEN SUBDIVIDED INTO SMALLER PANELS.
- 4.

(ABOVE) PROPOSED ENTRY GATE & CLASSROOM AS VIEWED FROM NORWOOD AVENUE





ROOF FORMS: SURROUNDING HOMES AND THE PROPOSED TEMPLE PROJECT EXHIBIT NEARLY EXCLUSIVELY PITCHED ROOFS OF VARIOUS SLOPES WITH COMBINATION OF GABLE AND HIPPED ROOF TYPES. A VARIETY OF ROOF SCALE IS FOUND IN SURROUNDING DEVELOPMENT AND THE PROPOSED PROJECT, INCLUDING LARGER PRIMARY ROOFS WITH SMALLER ACCENT GABLES AND DORMERS.

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IEA KROM	2740 RUBY AVENUE SAN JOSE, CALIFORNIA 95148 ADN: 652 20 014	PROJECT FILE NO. SP20-024	
ANDREW MANN ARCHITECTURE	360 LANGTON STREET, SUITE 302 SAN FRANCISCO, CALIFORNIA, 94103	TELEPHONE: 415-863-4134 ANDREWMANNARCHITECTURE.COM	
SIEGEL & STRAIN Architects	6201 DOYLE STREET, SUITE B EMERYVILLE, CALIFORNIA, 94608 TEL 510-547-8092	FAX 510-547-2604 SIEGELSTRAIN.COM	
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ORIGINAL SH 03/26/2 SCALE: 12" = 1' SHEET NUM	21 -0"	RAWN BY: AMA	




PROPOSED PROJECT (PQP)

2740 Ruby Avenue, San Jose, CA 95148

<u>COMPATIBILITY EXHIBIT: COMPARISON WITH NEARBY ASSEMBLY USES</u>

THE PROPOSED TEMPLE PROJECT INCLUDES THE FOLLOWING ELEMENTS WHICH ARE SIMILAR TO NEARBY ASSEMBLY USE SPACES. REFER TO PHOTOGRAPHS, PLANS, AND PROPOSED RENDERINGS ABOVE FOR VISUAL CONFIRMATION OF COMMON PROJECT ELEMENTS.

- BUILDING FORM, SCALE & ORIENTATION: BUILDING FORMS FOUND IN THE NEARBY ASSEMBLY USE SPACES AND PROPOSED TEMPLE PROJECT ARE GENERALLY RECTILINEAR AND ARE 1 TO 2 STORIES IN HEIGHT. GRACE CHURCH IS APPROXIMATELY 35'-11" TALL FROM ADJACENT FINISHED GRADE, NOT INCLUDING THE STEEPLE. THE FINISHED HEIGHT OF THE PRIMARY PORTION OF THE TEMPLE ROOF IS 35'-10" FROM ADJACENT FINISHED GRADE A SMALL ACCENT ROOF AND SPIRE EXTEND ABOVE. NEARBY ASSEMBLY USE SPACES SUCH AS EVERGREEN VALLEY UNITED METHODIST CHURCH AND GRACE CHURCH INCLUDE MULTIPLE STRUCTURES, TYPICALLY ONE STRUCTURE FOR THE SANCTUARY AND A SECOND STRUCTURE FOR COMMUNITY SERVICES. LIKE THE PROPOSED PROJECT. SOME NEARBY ASSEMBLY USE SPACES ARE ORIENTED PARALLEL TO STREET FRONTAGE, WHEREAS OTHERS ARE NOT.
- **EXTERIOR WALLS:** A COMBINATION OF OFF-WHITE STUCCO, VERTICAL AND 4 HORIZONTAL SIDING, AND STONE ARE SOME OF THE MATERIALS FOUND IN BOTH THE NEARBY ASSEMBLY USE SPACES. THE PROPOSED PROJECT INCORPORATES OFF-WHITE STUCCO, VERTICAL WOOD SIDING, AND STONE IN THE EXTERIOR WALL MATERIALS.
- DRIVEWAY WITH SURFACE PARKING

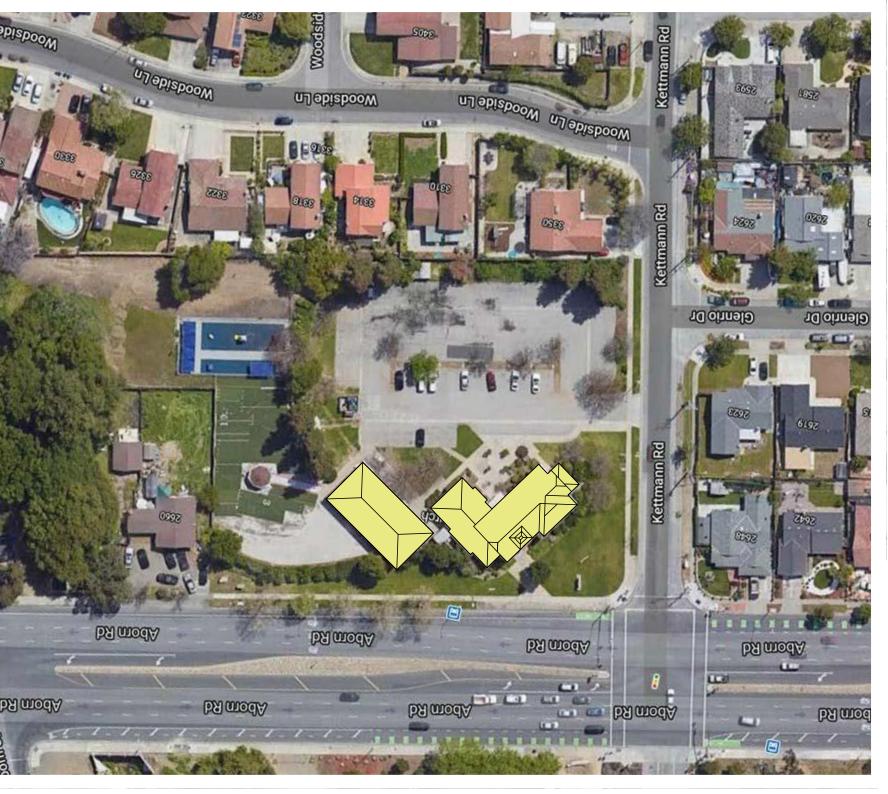

2 GRACE CHURCH G7.3 SCALE: 1" = 80'-0"





GRACE CHURCH (R-1-8)

2650 Aborn Rd, San Jose, CA 95121

ROOF MATERIAL & FORMS: BROWN OR NEUTRAL ROOF TILES SOMETIMES WITH COLORED ACCENT TILES ARE COMMONLY FOUND IN NEARBY ASSEMBLY USE DEVELOPMENT. THE PROPOSED PROJECT INCLUDES GRAY ROOF TILES WITH RED AND GREEN ACCENT TILES. NEARBY ASSEMBLY USE SPACES AND THE PROPOSED TEMPLE PROJECT EXHIBIT NEARLY EXCLUSIVELY PITCHED ROOFS OF VARIOUS SLOPES WITH COMBINATION OF GABLE, HIPPED, AND SHED ROOF FORMS. COVERED PORCHES ARE ALSO FOUND IN BOTH NEARBY ASSEMBLY USE DEVELOPMENT AND THE PROPOSED PROJECT. COVERED PORCHES UTILIZE ROOF OVERHANG AND ARE SUPPORTED BY COLUMNS SIMILAR IN COLOR TO THE EXTERIOR WALLS AND TRIM.

VEHICULAR ENTRY AND PARKING: NEARBY ASSEMBLY USE DEVELOPMENT EXCLUSIVELY EXHIBIT SURFACE PARKING LOTS AND OFTEN INCLUDE ONE DRIVEWAY. THE PROPOSED TEMPLE PROJECT ALSO PROVIDES ONE

- SETBACKS & STREET FRONTAGE: SETBACKS OF NEARBY ASSEMBLY USE SPACES VARY, USUALLY DEPENDING ON LOT SIZE. LARGER LOTS OFTEN EXHIBIT LARGER BUILDING SETBACKS, WHEREAS SMALLER LOTS TYPICALLY EXHIBIT SMALLER SETBACKS WHICH MAINTAIN OR EXCEED ZONING REQUIREMENTS BUILDINGS ARE TYPICALLY SITUATED CLOSEST TO THE STREET FRONTAGE(S). THE SITE PLACEMENT OF NEARBY ASSEMBLY USE SPACES, SUCH AS THE SANCTUARY AT GRACE CHURCH, YIELD PROMINENT VIEWS FROM STREET FRONTAGES, AND MORE MODEST VIEWS ALONG THE SIDE AND REAR PROPERTY LINES WHERE THE BUILDINGS ARE ADJACENT TO RESIDENCES. THIS IS CONSISTENT WITH THE SITE PLACEMENT AND VIEWS CREATED BY THE PROPOSED PROJECT.
- LOCATION: NEARBY ASSEMBLY USE DEVELOPMENT IN EVERGREEN IS TYPICALLY FRONTED BY A MAIN ROAD AND SURROUNDED BY 1 AND 2-STORY RESIDENCES.





EVERGREEN VALLEY UNITED METHODIST CHURCH (R-1-5)

3520 San Felipe Rd, San Jose, CA 95135

OPERATIONS: A COMPARISON BETWEEN GRACE CHURCH AND THE PROPOSED PROJECT:

CAPACITY: GRACE CHURCH ADVERTISES AN EVENT CAPACITY OF 350 PEOPLE. THE PROPOSED PROJECT INCLUDES A VOLUNTARY CAP OF 300 VISITORS

HOURS OF OPERATION: GRACE CURCH: 7AM-10PM, PROPOSED PROJECT: 9AM-10PM.

PRESCHOOL: IS OFFERED AT GRACE CHURCH, BUT NOT THE PROPOSED PROJECT

HALL RENTAL: GRACE CHURCH TYPICALLY OFFERS PUBLIC RENTAL OF THE COMMUNITY HALL TWICE EVERY WEEK OF THE YEAR. THE HALL WAS OCCUPIED APPROXIMATELY 79 TIMES IN 2019 (ACCORDING TO GRACE CHURCH ONLINE HALL RESERVATION SYSTEM). THE PROPOSED PROJECT DOES NOT OFFER PUBLIC RESERVATIONS OF THE COMMUNITY HALL.

OUTDOOR EVENTS: ARE ALLOWED AT GRACE CHURCH AND THE PROPOSED PROJECT

ALCOHOL: IS SERVED AT BOTH GRACE CHURCH AND THE PROPOSED PROJECT

CATERING: IS PROVIDED AT BOTH GRACE CHURCH AND THE PROPOSED PROJECT


SMOKING: IS ALLOWED IN A DEDICATED ON-SITE SMOKING SPOT AT THE PROPOSED PROJECT IN EFFORT TO ELIMINATE SMOKING AROUND NEARBY RESIDENCES. IT IS UNKNOWN IF GRACE CHURCH OFFERS A DEDICATED ON-SITE SMOKING SPOT.


AMPLIFIED SOUND: IS PERMITTED INDOORS AT GRACE CHURCH. THIS PROJECT PROPOSES AMPLIFIED SOUND INDOORS AND AT THE EXTERIOR DURING SELECT RELIGIOUS ACTIVITIES. EXTERIOR AMPLIFIED SOUND TO ADHERE TO CITY PERMISSIVE STANDARDS & REGULATIONS.

REV ISSUED FOR DATE REV 1 SUP 03/26/21 REV 2 SUP 10/19/21 REV 3 SUP 02/09/22	
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ANDREW H. MANN C 26086 REN. 3/31/23	
WAT KHMER KAMPUCHEA KROM 2740 RUBY AVENUE SAN JOSE, CALIFORNIA 95148 APN: 652-29-014 PROJECT FILE NO. SP20-024	
ANDREW MANN ARCHITECTURE 360 LANGTON STREET, SUITE 302 SAN FRANCISCO, CALIFORNIA, 94103 TELEPHONE: 415-863-4134 ANDREWMANNARCHITECTURE.COM	
SIEGEL & STRAIN Architects 6201 DOYLE STREET, SUITE B 6201 DOYLE STREET, SUITE B EMERYVILLE, CALIFORNIA, 94608 TEL 510-547-2604 SIEGELSTRAIN.COM	
ORIGINAL SHEET ISSUE DATE: 03/26/21 SCALE: 1" = 80'-0" SHEET NUMBER: G7.3	


ABBREVIATIONS


ABV.	ABOVE	NAT.	NATURAL
ACOUS.	ACOUSTICAL	N.I.C.	NOT IN CONTRACT
		-	
A.D.	AREA DRAIN	NO. or #	NUMBER
ADJ.	ADJUSTABLE	NOM.	NOMINAL
APPROX	APPROXIMATE	N.T.S.	NOT TO SCALE
ARCH.	ARCHITECTURAL	O.A.	OVERALL
			-
ASPH.	ASPHALT	O.C.	ON CENTER
BD.	BOARD	O.D.	OUTSIDE DIAMETER
BITUM.	BITUMINOUS	OPNG.	OPENING
BLDG.	BUILDING	OPP.	OPPOSITE
-			
BLKG.	BLOCKING	OS	OCCUPANCY SENSOR
BM.	BEAM	#	POUND OR NUMBER
BOT.	ВОТТОМ	PL.	PLATE
CAB.	CABINET	P. LAM.	PLASTIC LAMINATE
CEM.	CEMENT	PLAS.	PLASTER
CER.	CERAMIC	PLYWD.	PLYWOOD
CL	CENTER LINE	PR.	PAIR
	-		
CLO.	CLOSET	PROP.	PROPERTY
CLR.	CLEAR	P.T.	PRESSURE TREATED
COL.	COLUMN	PTD.	PAINTED
CONC.	CONCRETE	R.	RISER OR RADIUS
CONSTR.	CONSTRUCTION	R.A.	RETURN AIR
CONT.	CONTINUOUS	RAD.	RADIUS
CTR.	CENTER	RCP	REFLECTED CEILING PLAN
	-	-	
D	DRYER	REF.	REFERENCE
DBL.	DOUBLE	REFR.	REFRIGERATOR
DET.	DETAIL	RGTR.	REGISTER
DIA.	DIAMETER	REINF.	REINFORCED
DIM.	DIMENSION	REQ.	REQUIRED
DISPO.	DISPOSAL	RM.	ROOM
D.W.	DISH WASHER	R.O.	ROUGH OPENING
DR.	DOOR	RDWD.	REDWOOD
DWR.	DRAWER	R.W.L.	RAIN WATER LEADER
DWG.	DRAWING	SCHED.	SCHEDULE
	EXISTING	SECT.	
(E)			SECTION
EL.	ELEVATION	SH.	SHELF
ELEC.	ELECTRICAL	SHR.	SHOWER
ELEV.	ELEVATION or ELEVATOR	S.I.D.	SEE INTERIOR DRAWINGS
EMP	ELEC. MECH. PLUMBING PLAN	SIM.	SIMILAR
ENCL.	ENCLOSURE	SL.	SLOPE
EQ.	EQUAL	S.L.A.D.	SEE LANDSCAPE ARCH. DRAV
EXT.	EXTERIOR	SPEC.	SPECIFICATION
FDN.	FOUNDATION	SQ.	SQUARE
FIN.	FINISH	SSD.	SEE STRUCTURAL DRAWINGS
FLO.	FLOOR	SST.	STAINLESS STEEL
FLASH.	FLASHING	STD.	STANDARD
FLOUR.	FLOURESCENT	STL.	STEEL
F.O.	FACE OF	STOR.	STORAGE
FT.	FOOT	STRUCT.	STRUCTURAL
FTG.	FOOTING	SYM.	SYMMETRICAL
FURR.	FURRING	Т.	TREAD
GA.	GAUGE	T.B.	TOWEL BAR
GALV.	GALVANIZED	TEL.	TELEPHONE
GL.	GLASS	T&G	TONGUE & GROOVE
GR.	GRADE	THK.	THICK
GYP.	GYPSUM	Т.О.	TOP OF
H.B.	HOSE BIB	TV	TELEVISION
HDWD.	HARDWOOD	TYP.	TYPICAL
HDWE.	HARDWARE	U.O.N.	UNLESS OTHERWISE NOTED
HT.	HEIGHT	VERT.	VERTICAL
HORIZ.	HORIZONTAL	VGDF.	VERTICAL GRAIN DOUGLAS F
HR.	HOUR	V.I.F.	VERIFY IN FIELD
I.D.	INSIDE DIAMETER	W	WASHING MACHINE
INSUL.	INSULATION	W.H.	WATER HEATER
INT.	INTERIOR	W/	WITH
JT.	JOINT	WD.	WOOD
KIT.	KITCHEN	WIND.	WINDOW
LAM.	LAMINATE	W/O	WITHOUT
LAV.	LAVATORY	W.O.	WHERE OCCURS
LOC.	LOCATION	W.O. W.P.	WATERPROOF
LT.	LIGHT	WSCT.	WAINSCOTT
MAX.	MAXIMUM	WT.	WEIGHT
M.C.	MEDICINE CABINET		
MECH.	MECHANICAL		
-			
MEMB.	MEMBRANE		
MET.	METAL		
MFR.	MANUFACTURER		
MIN.	MINIMUM		
MISC.	MISCELLANEOUS		
MTD.	MOUNTED		

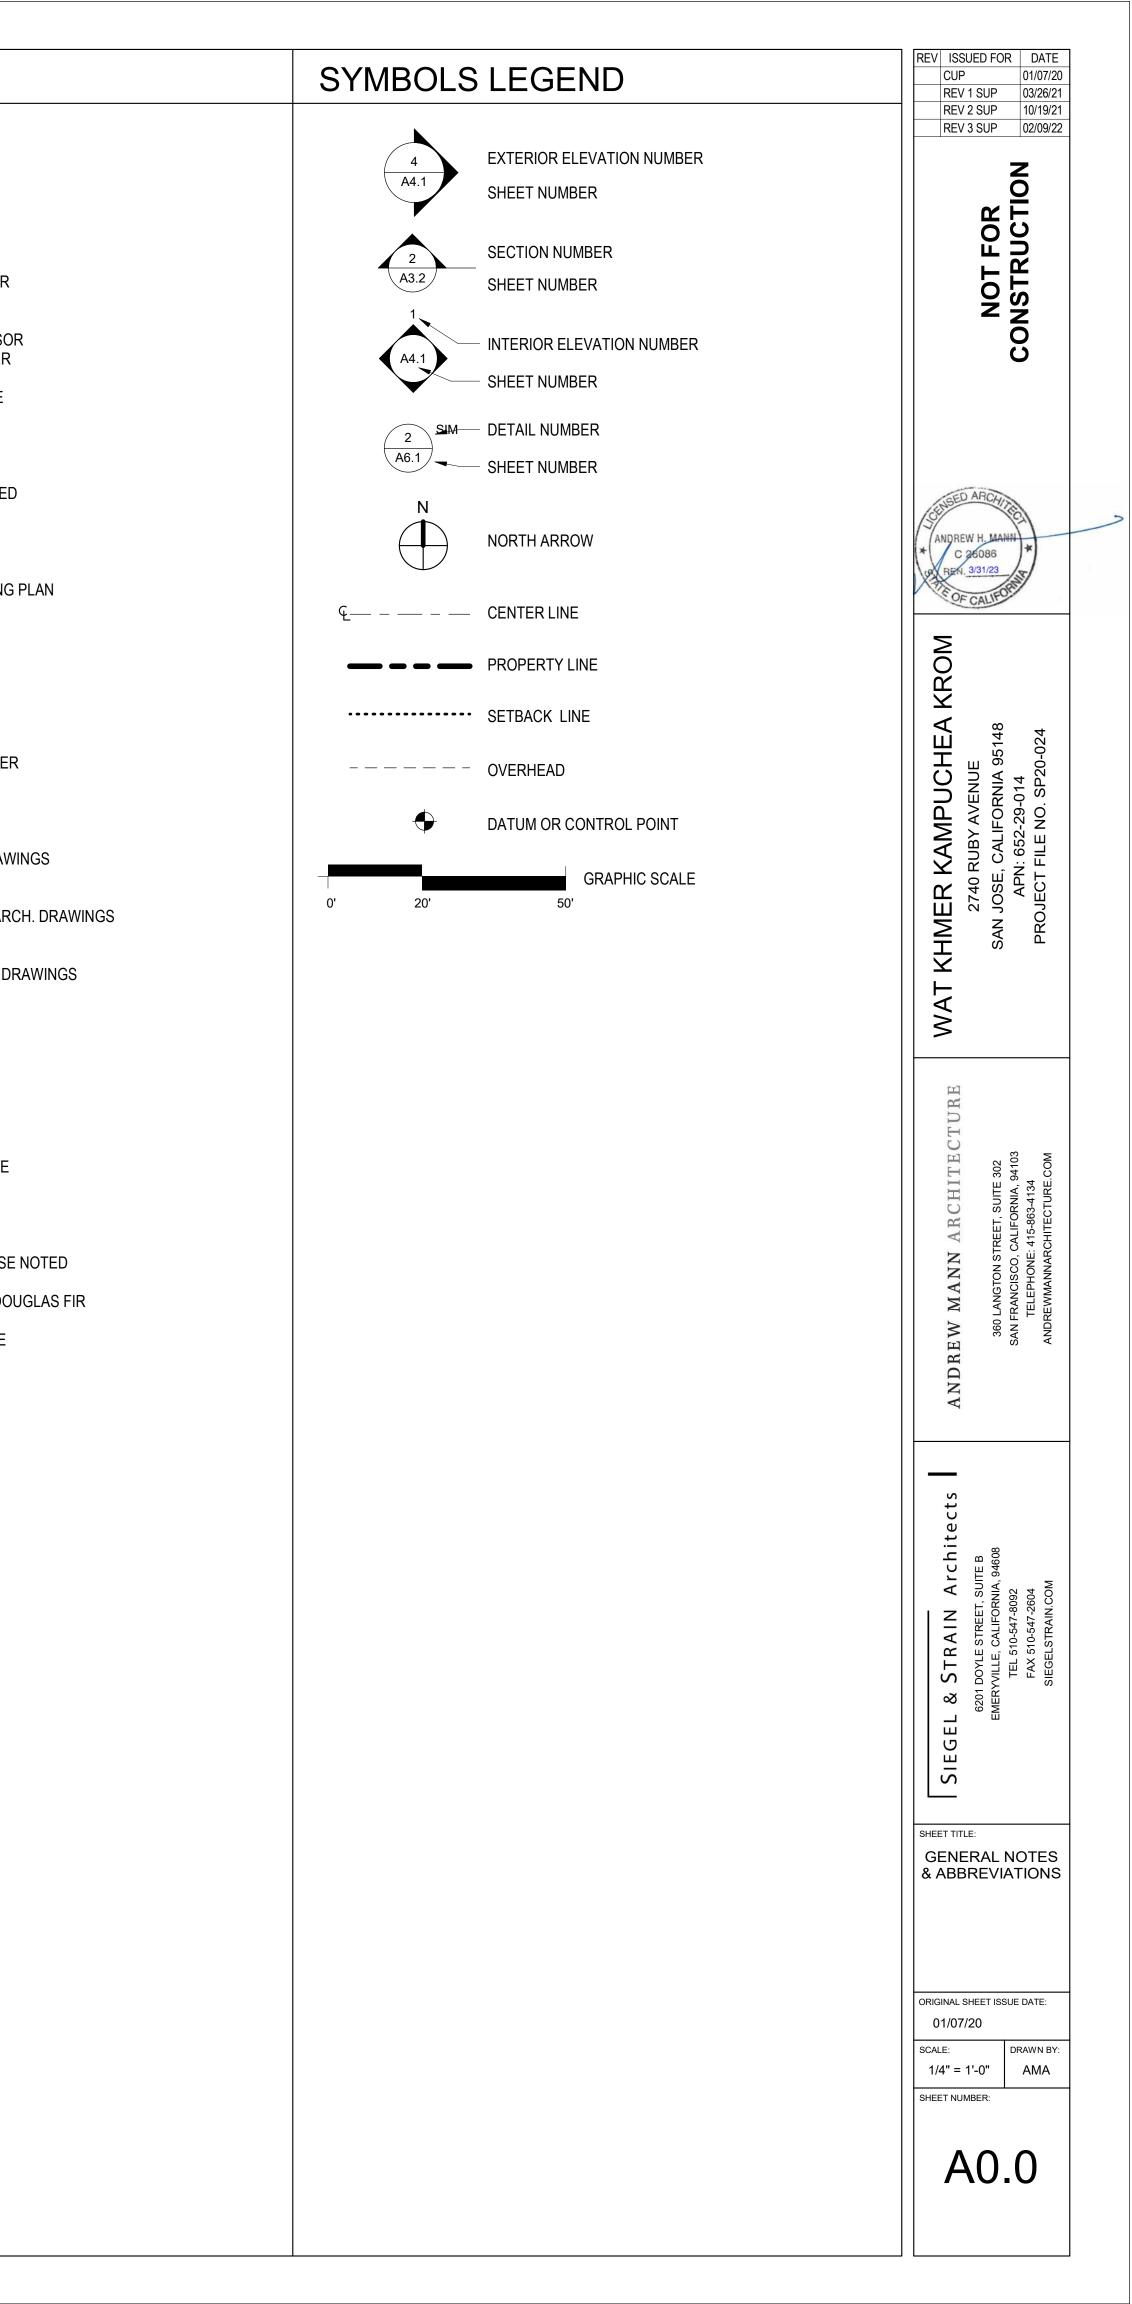

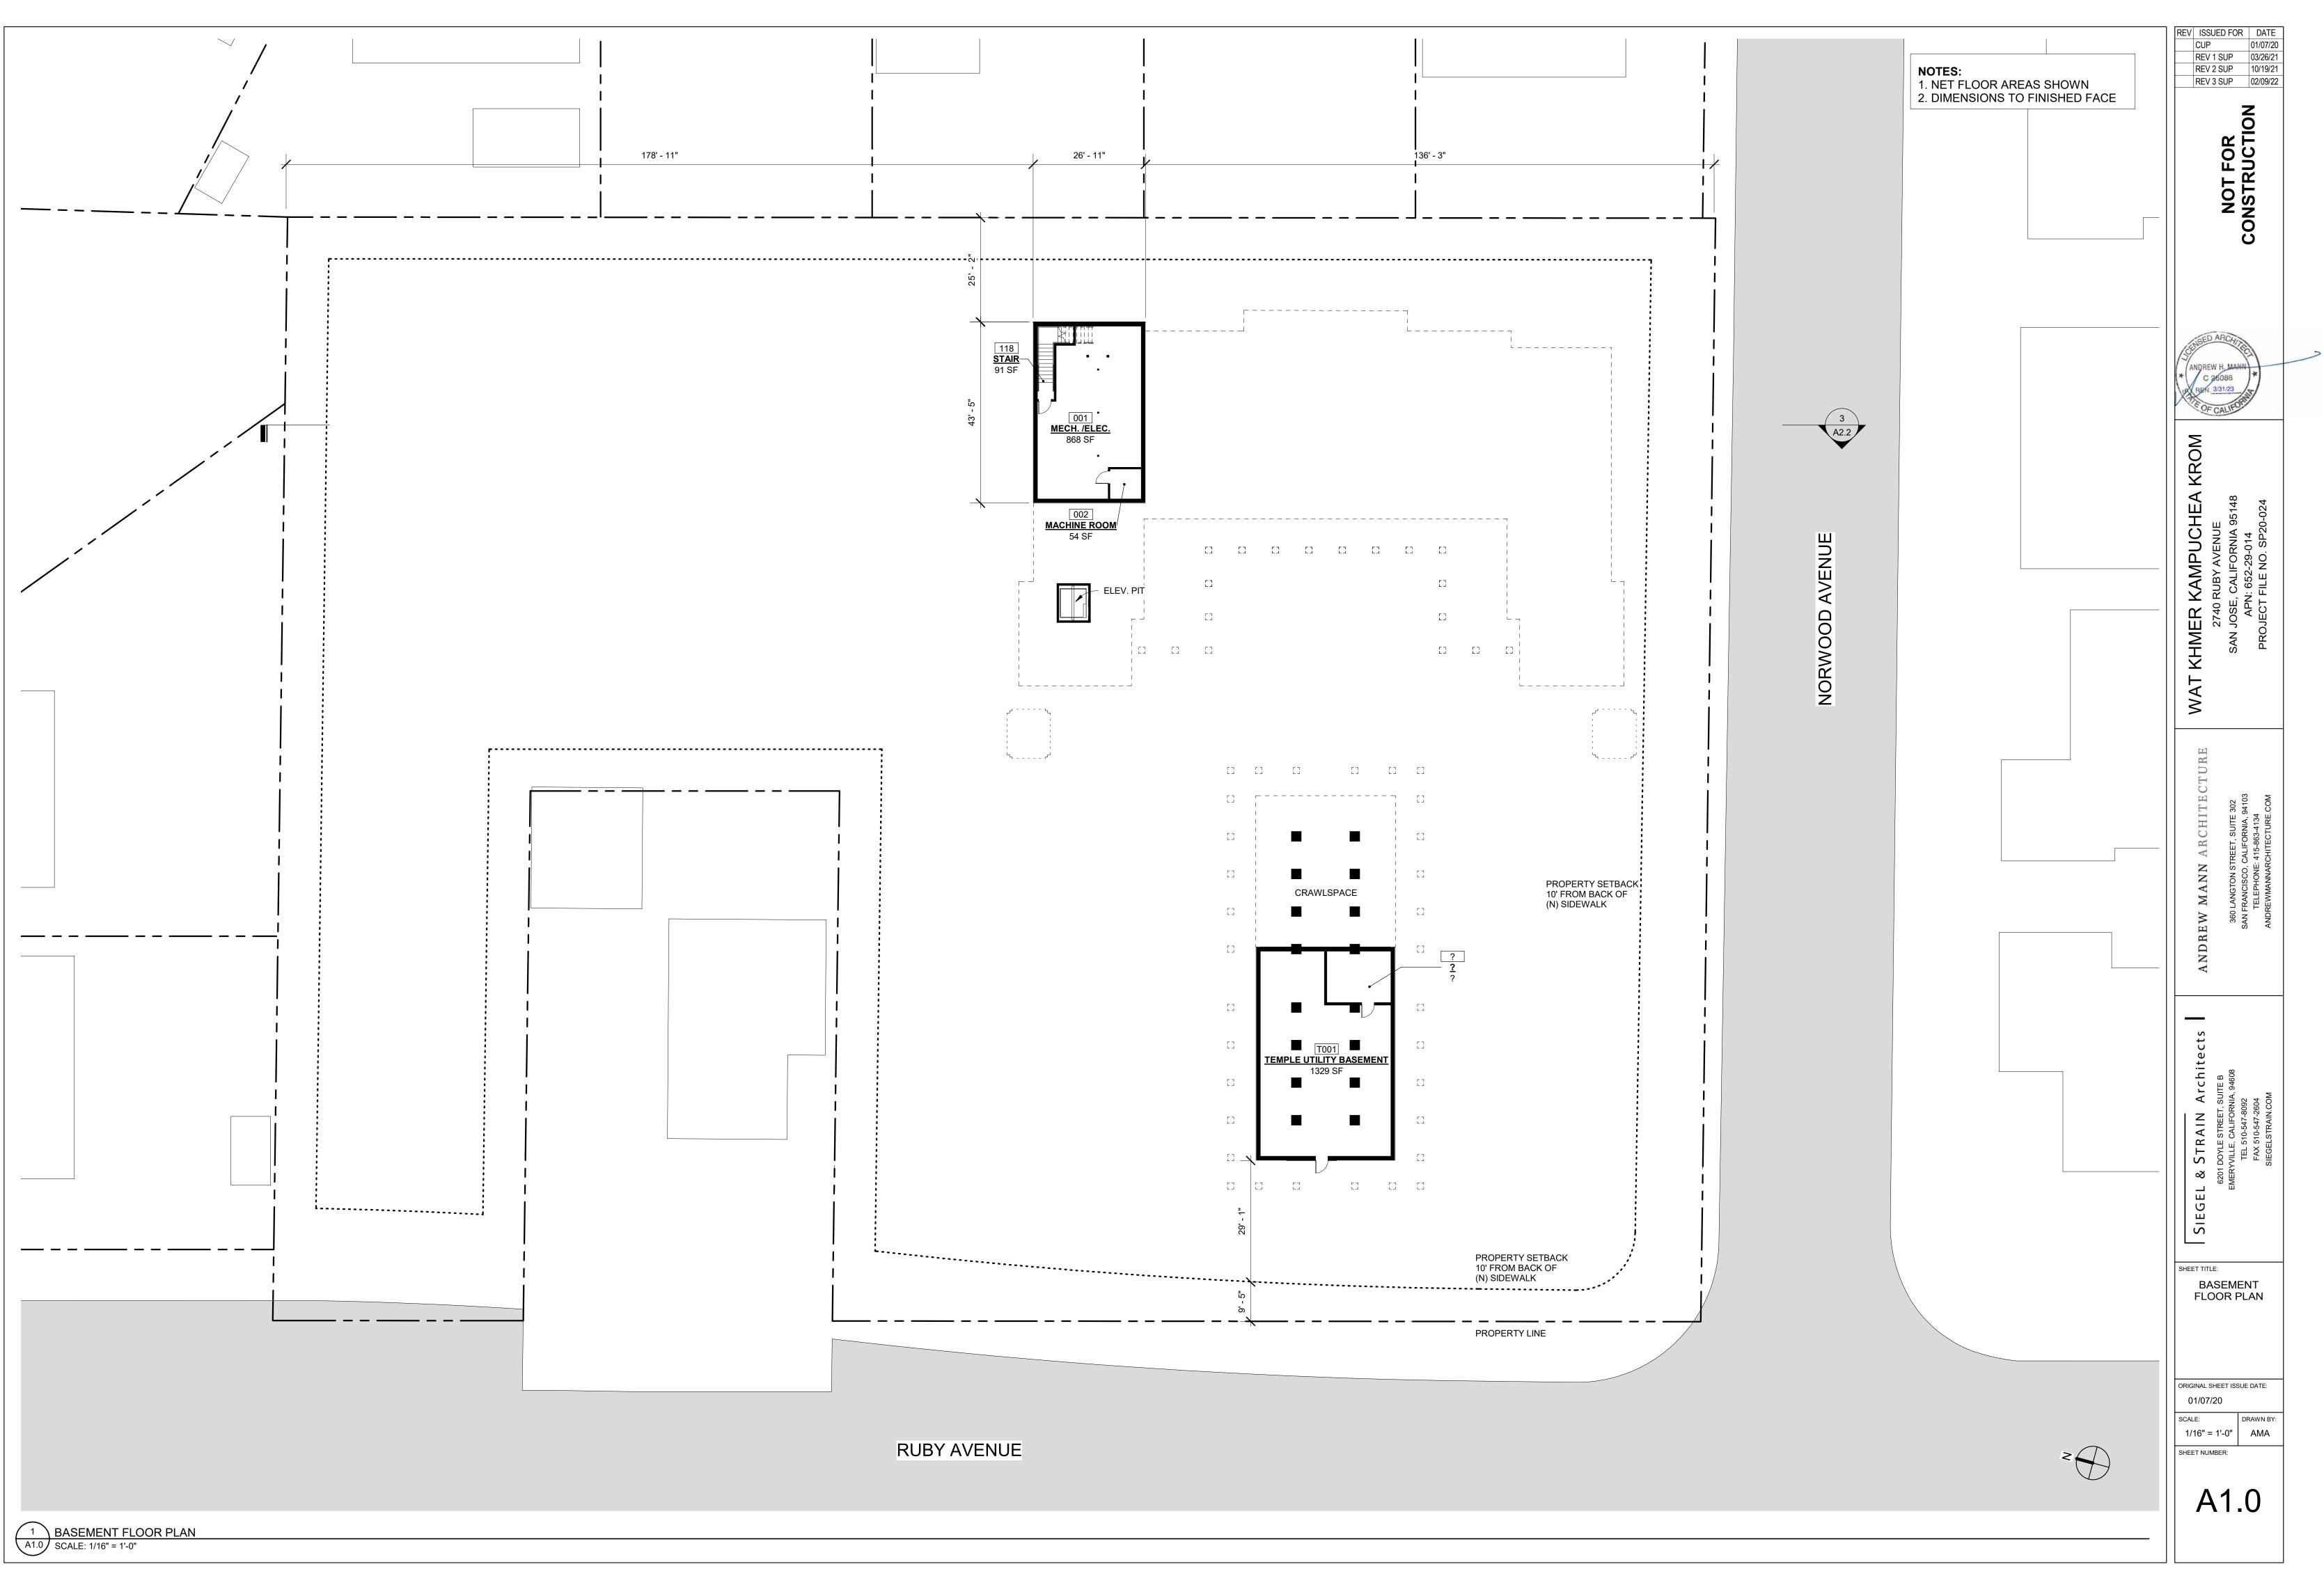





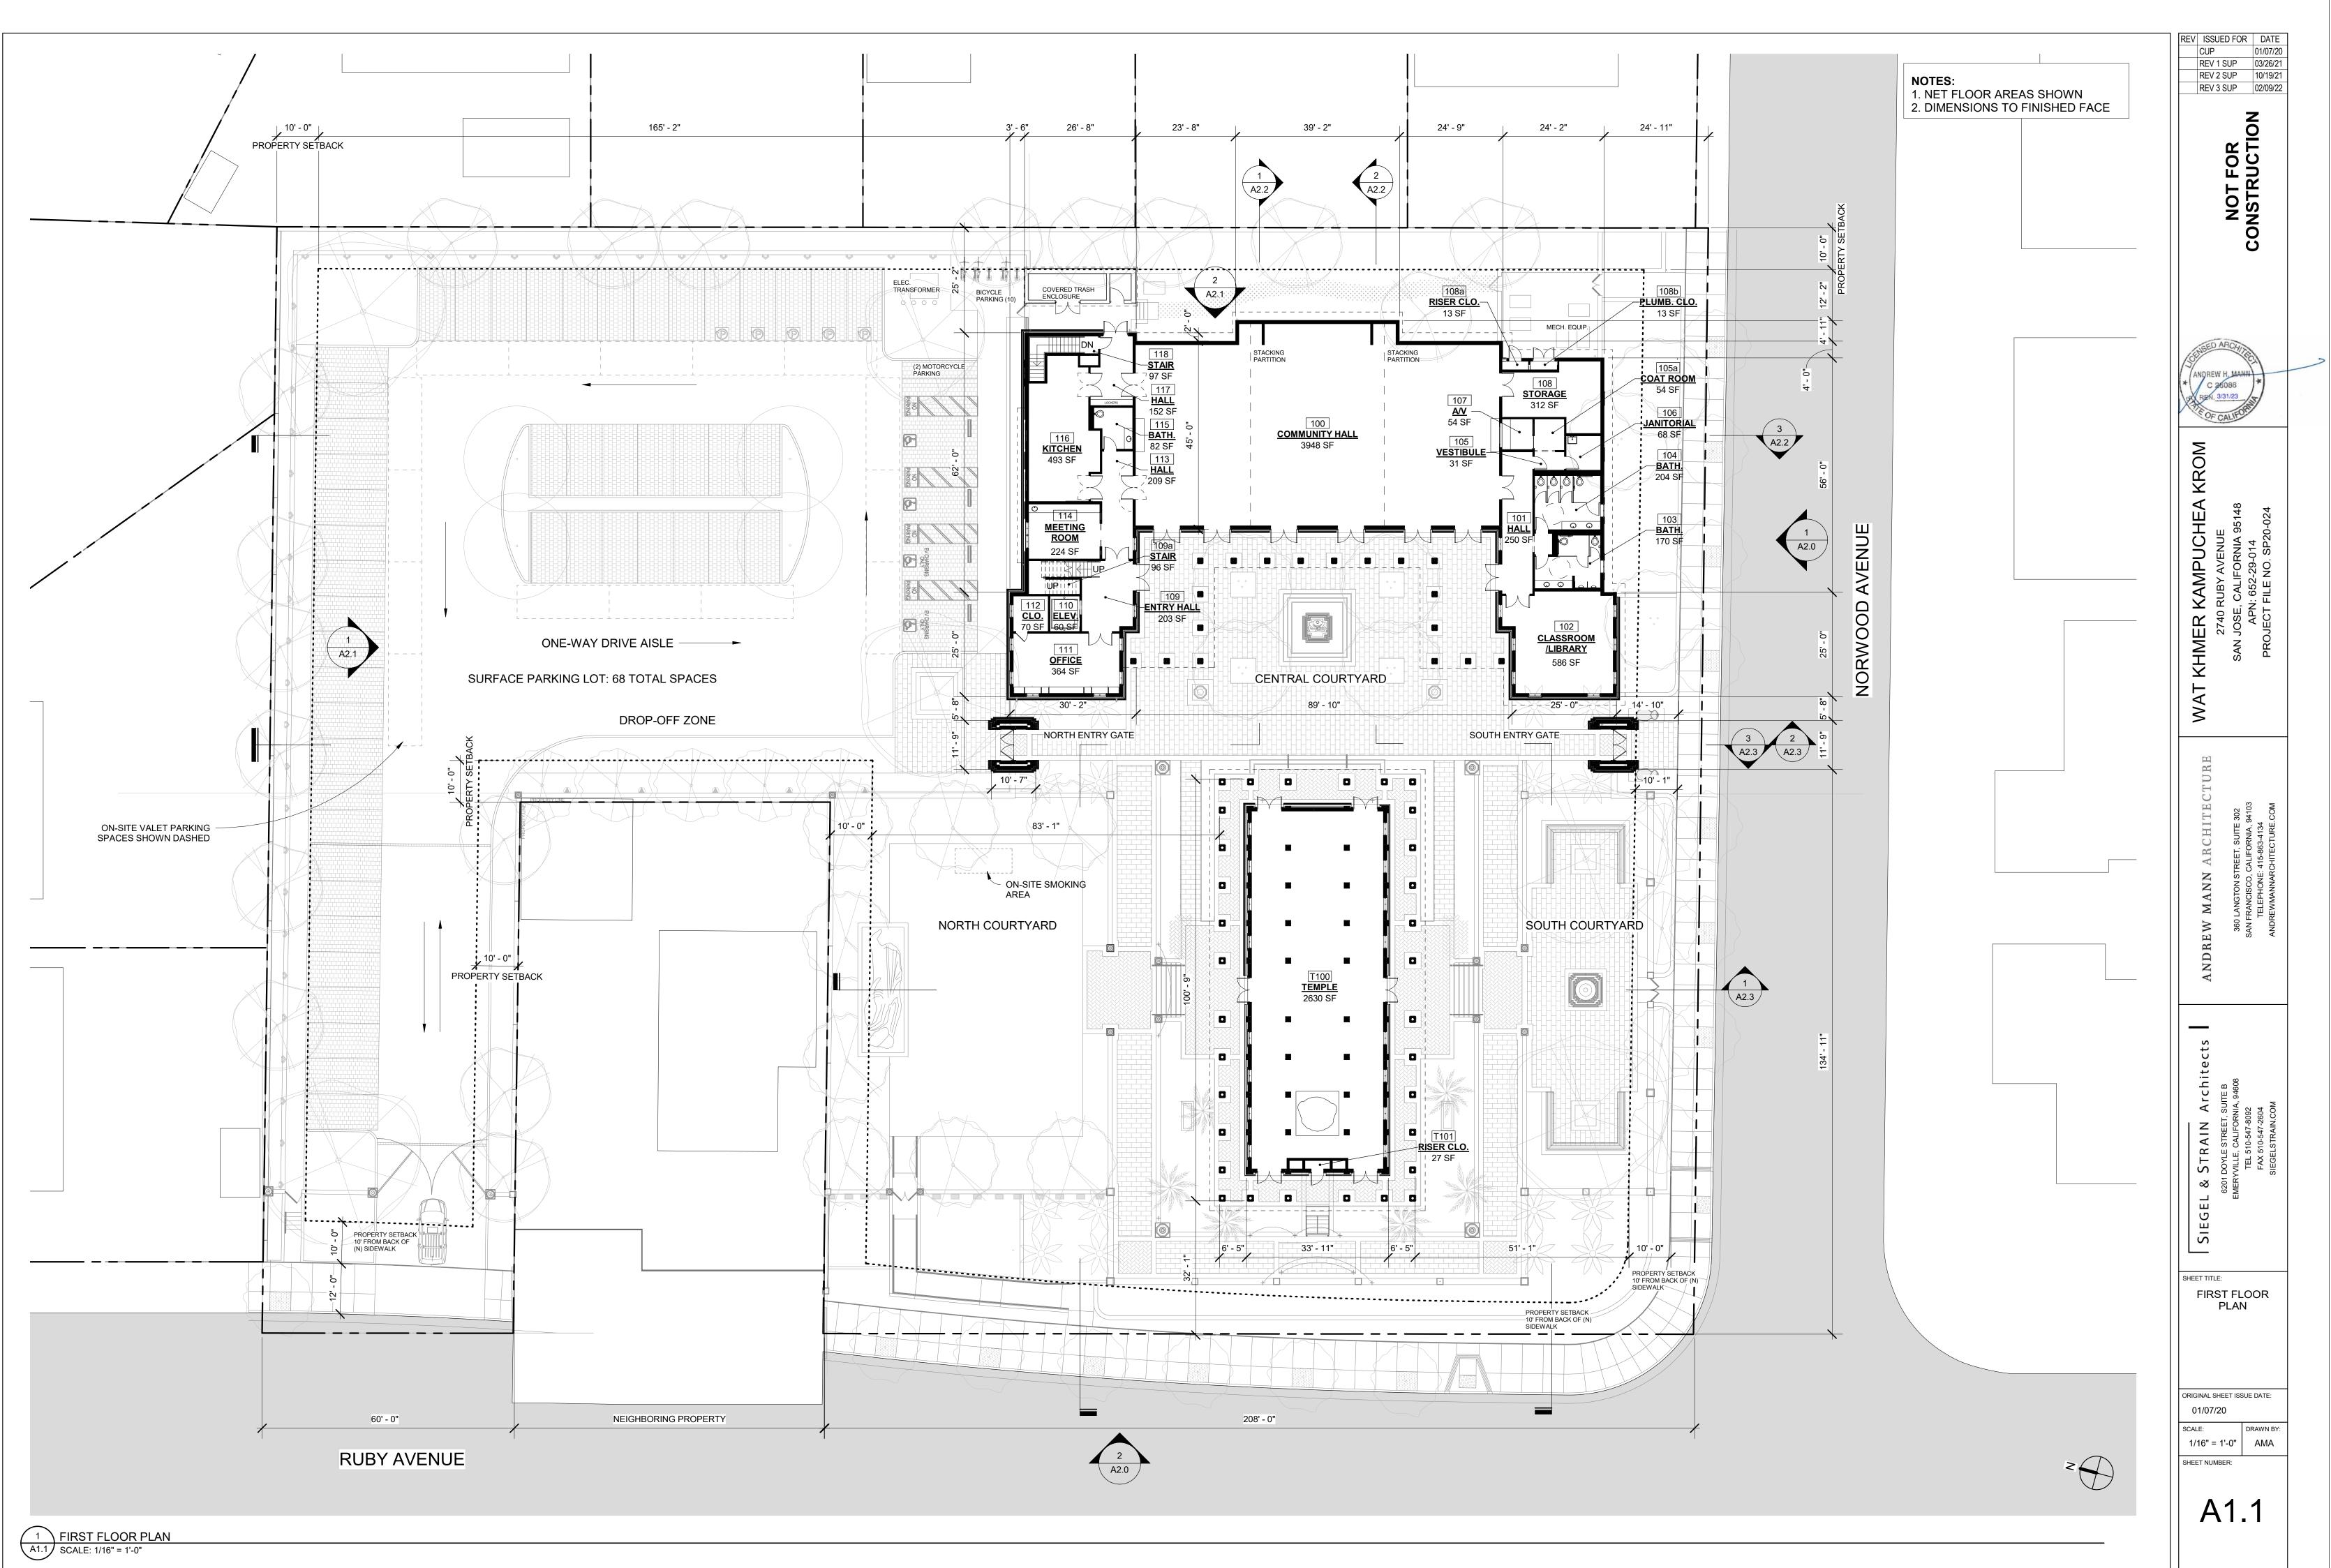


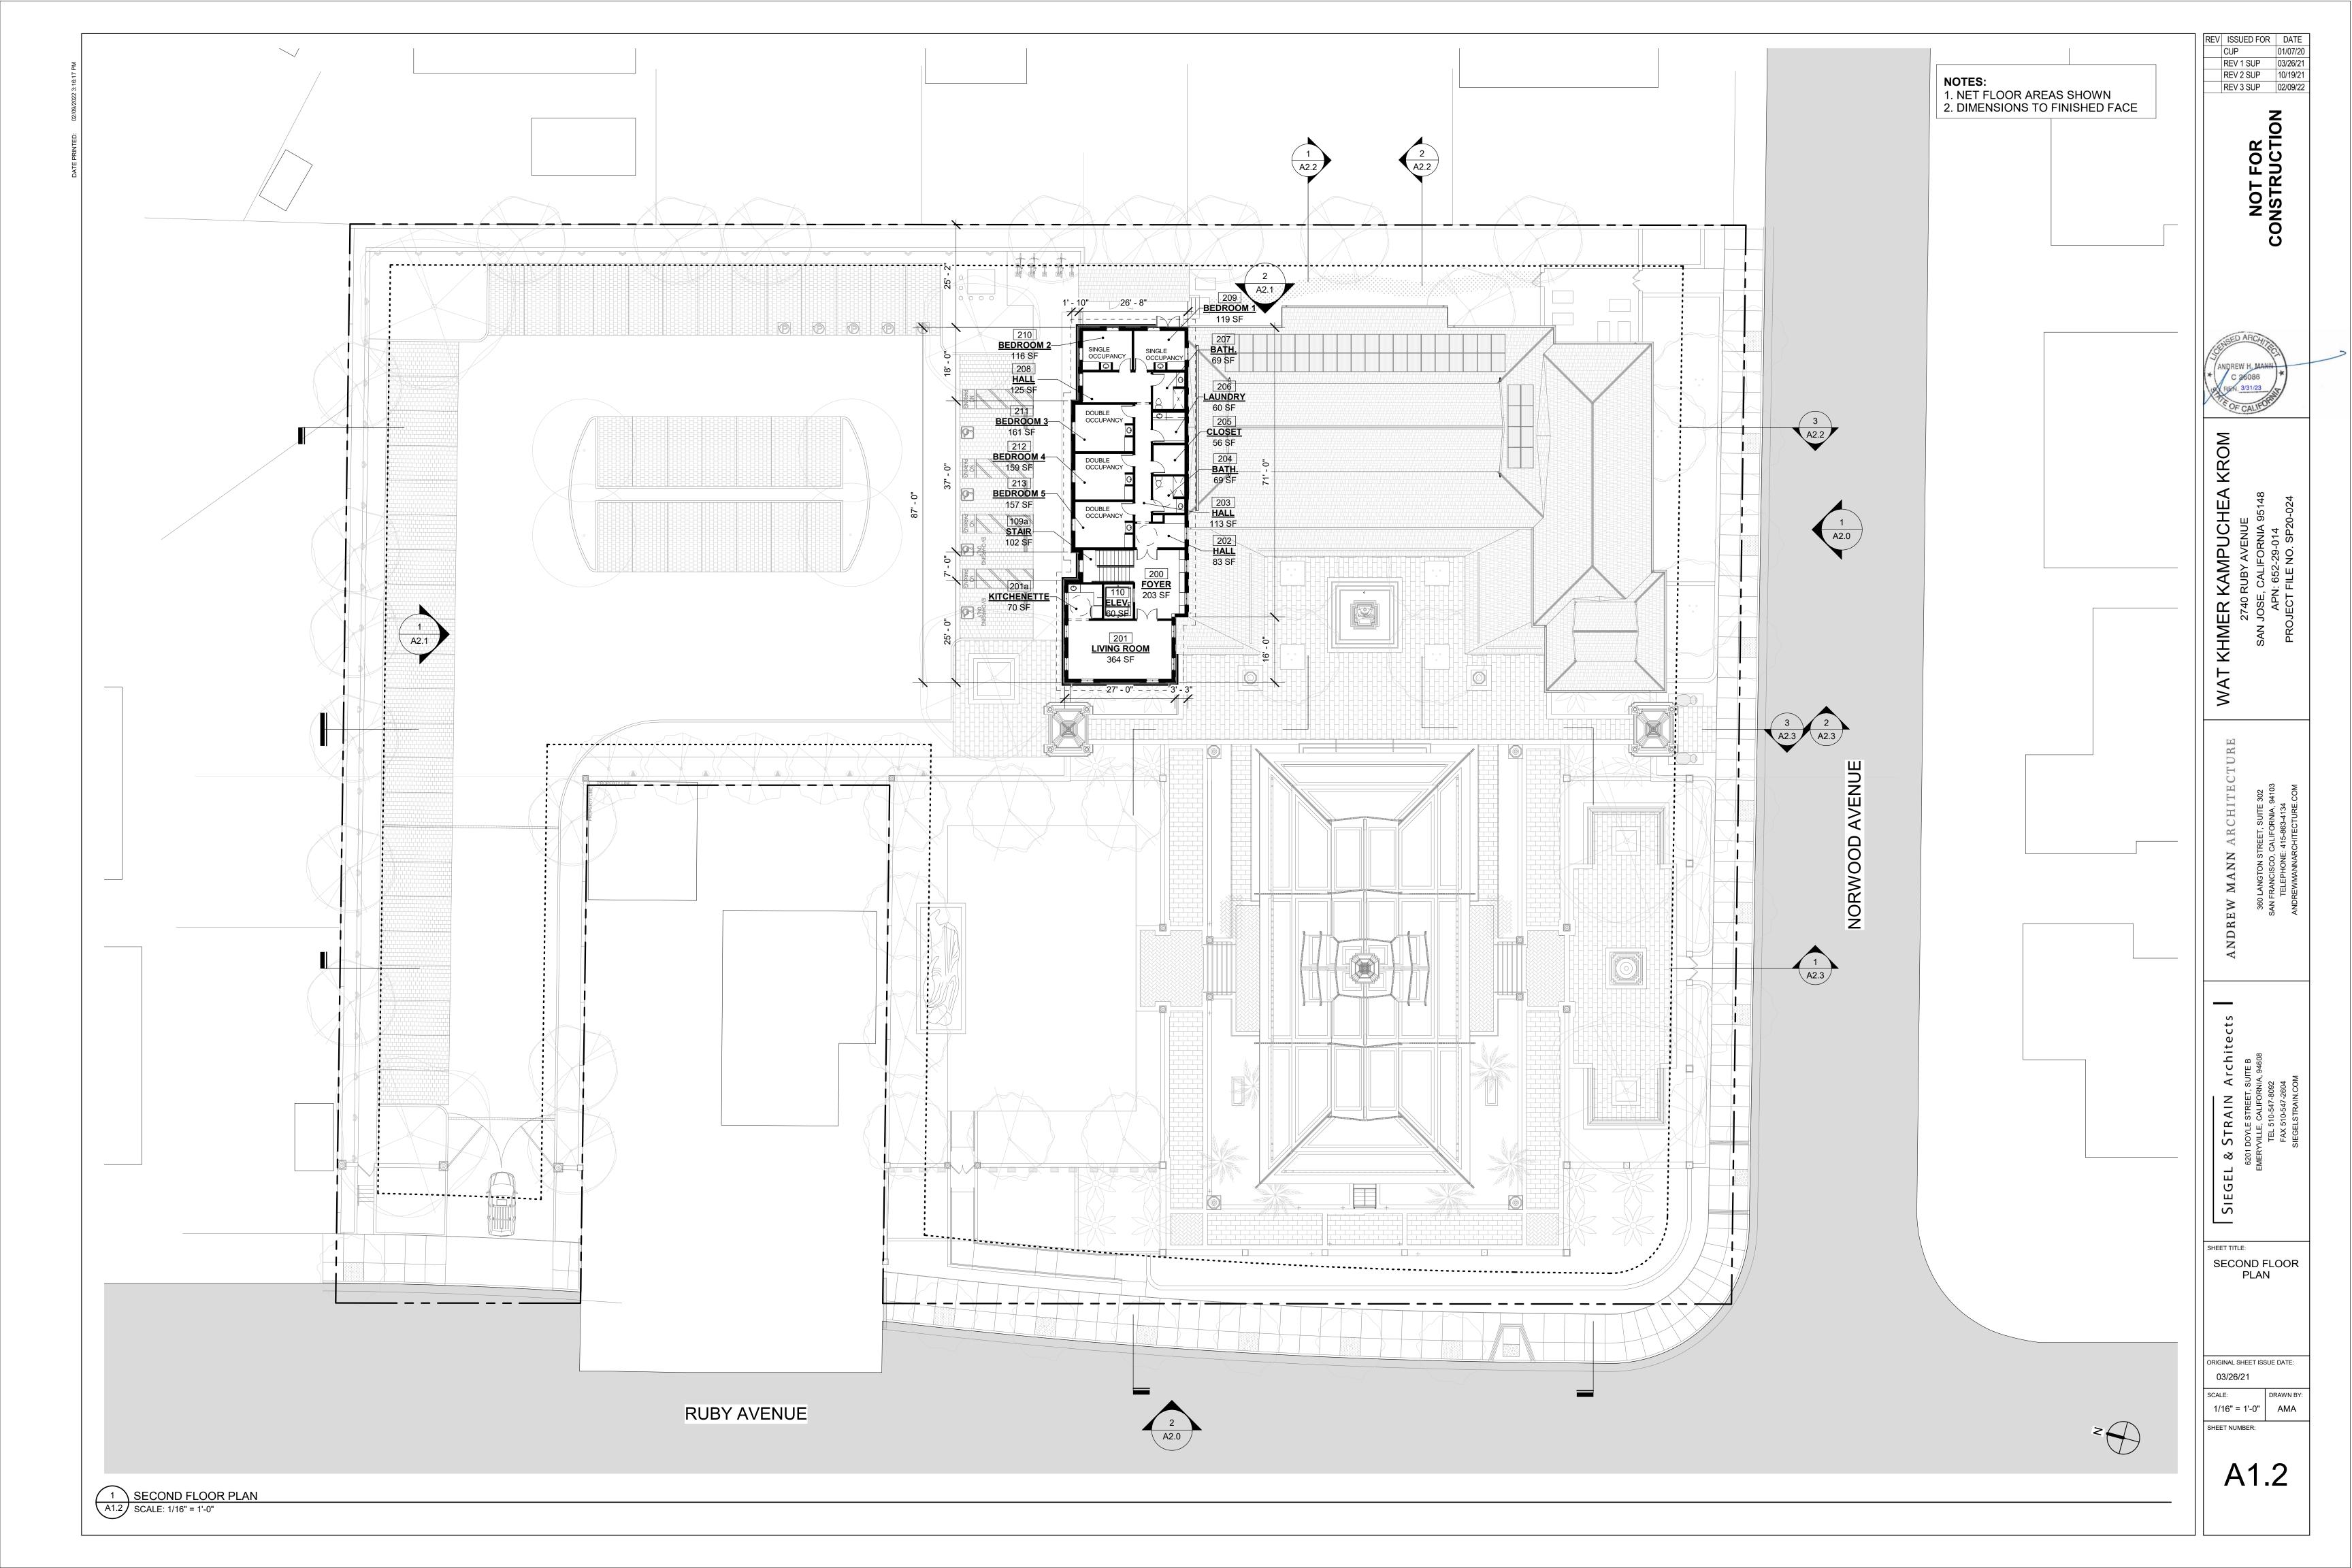





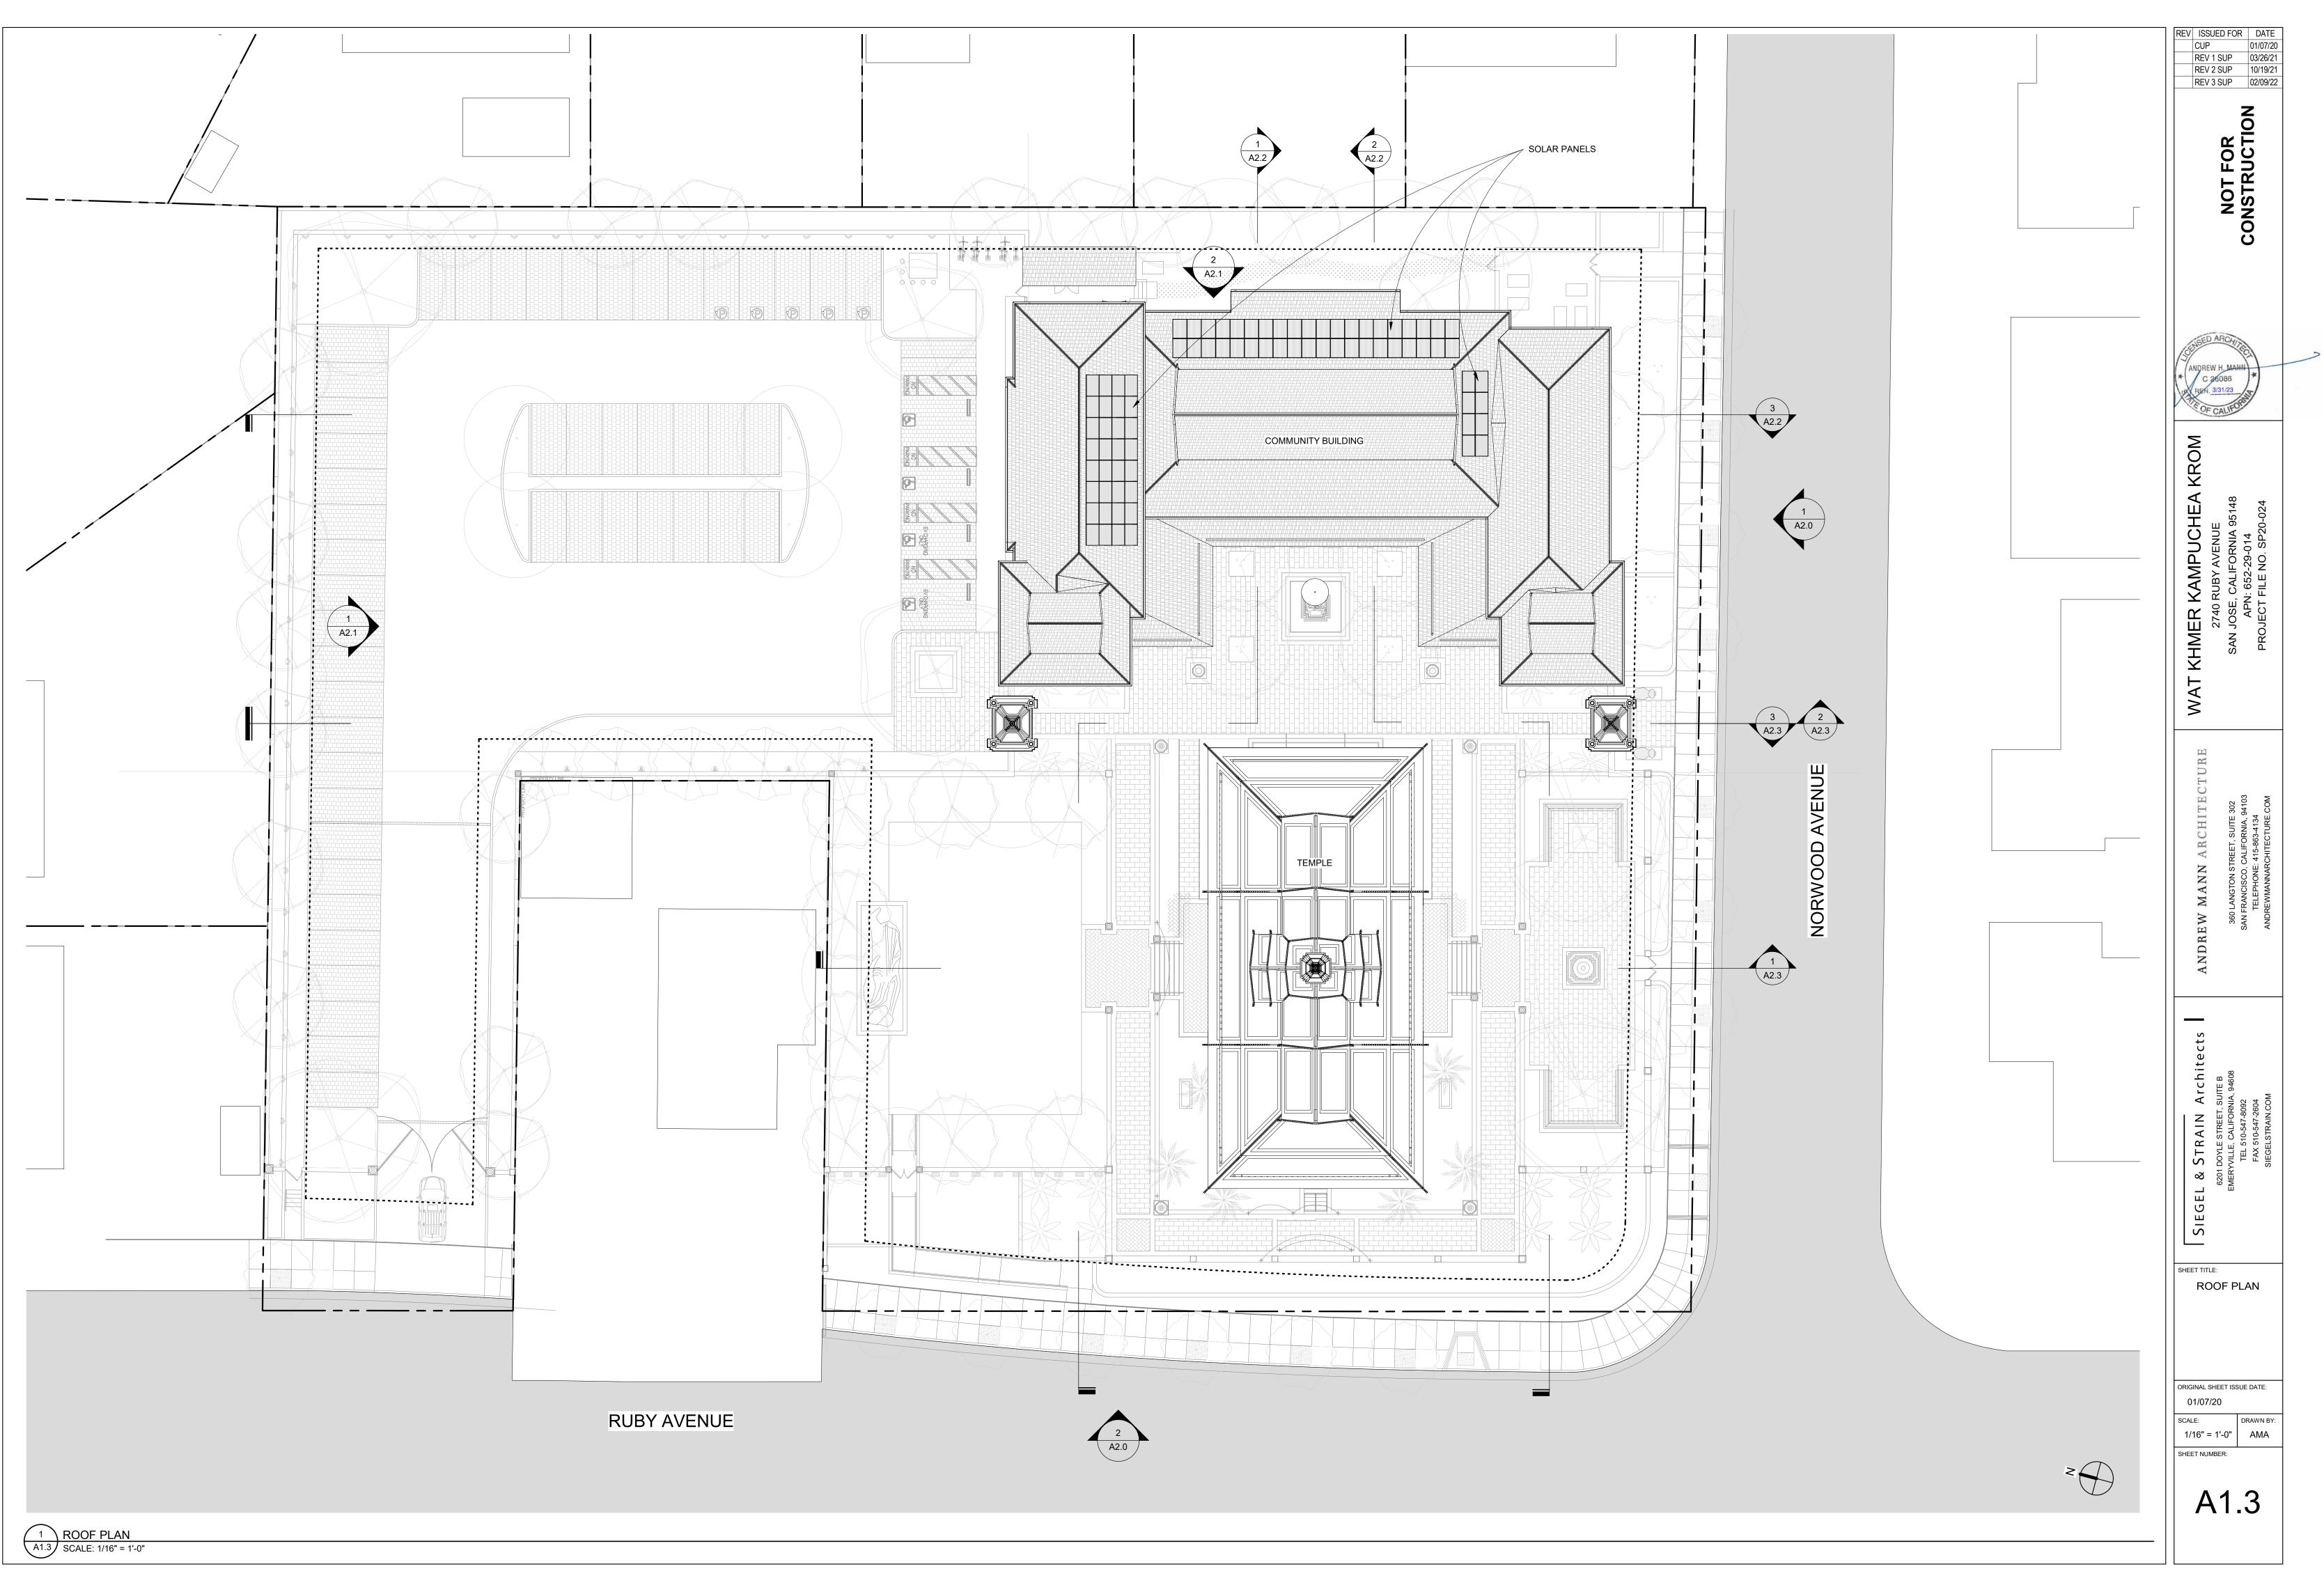

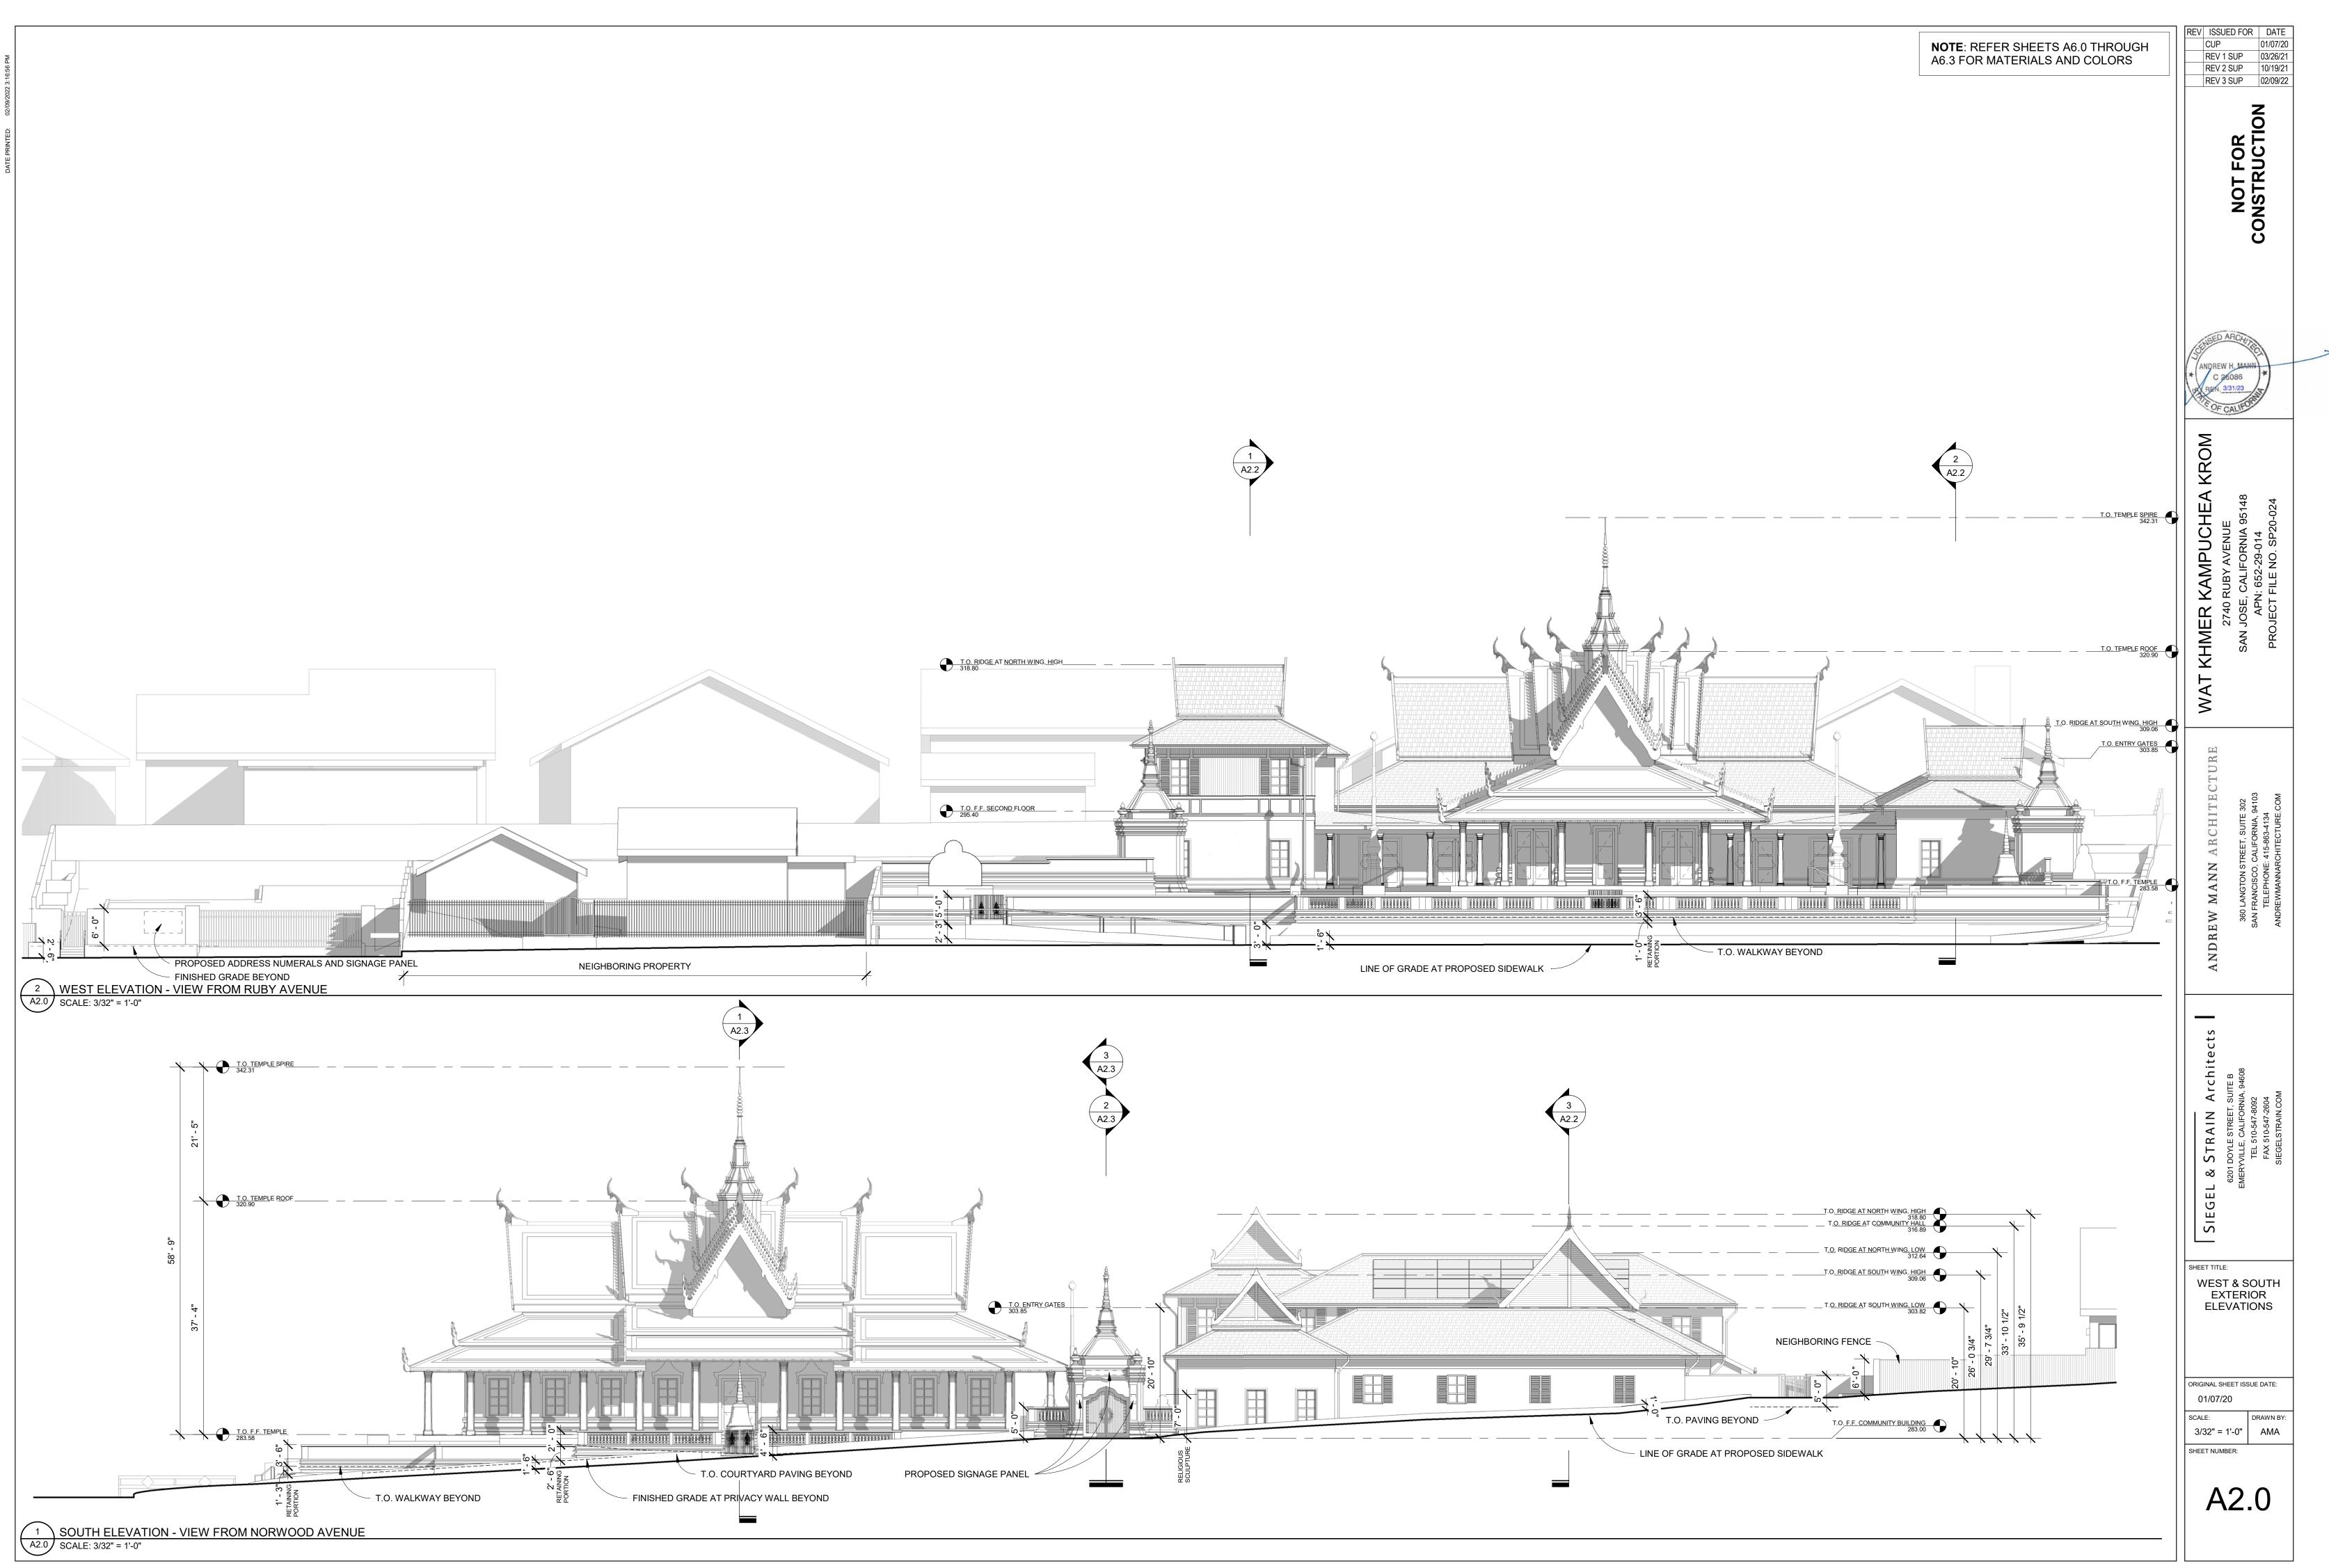

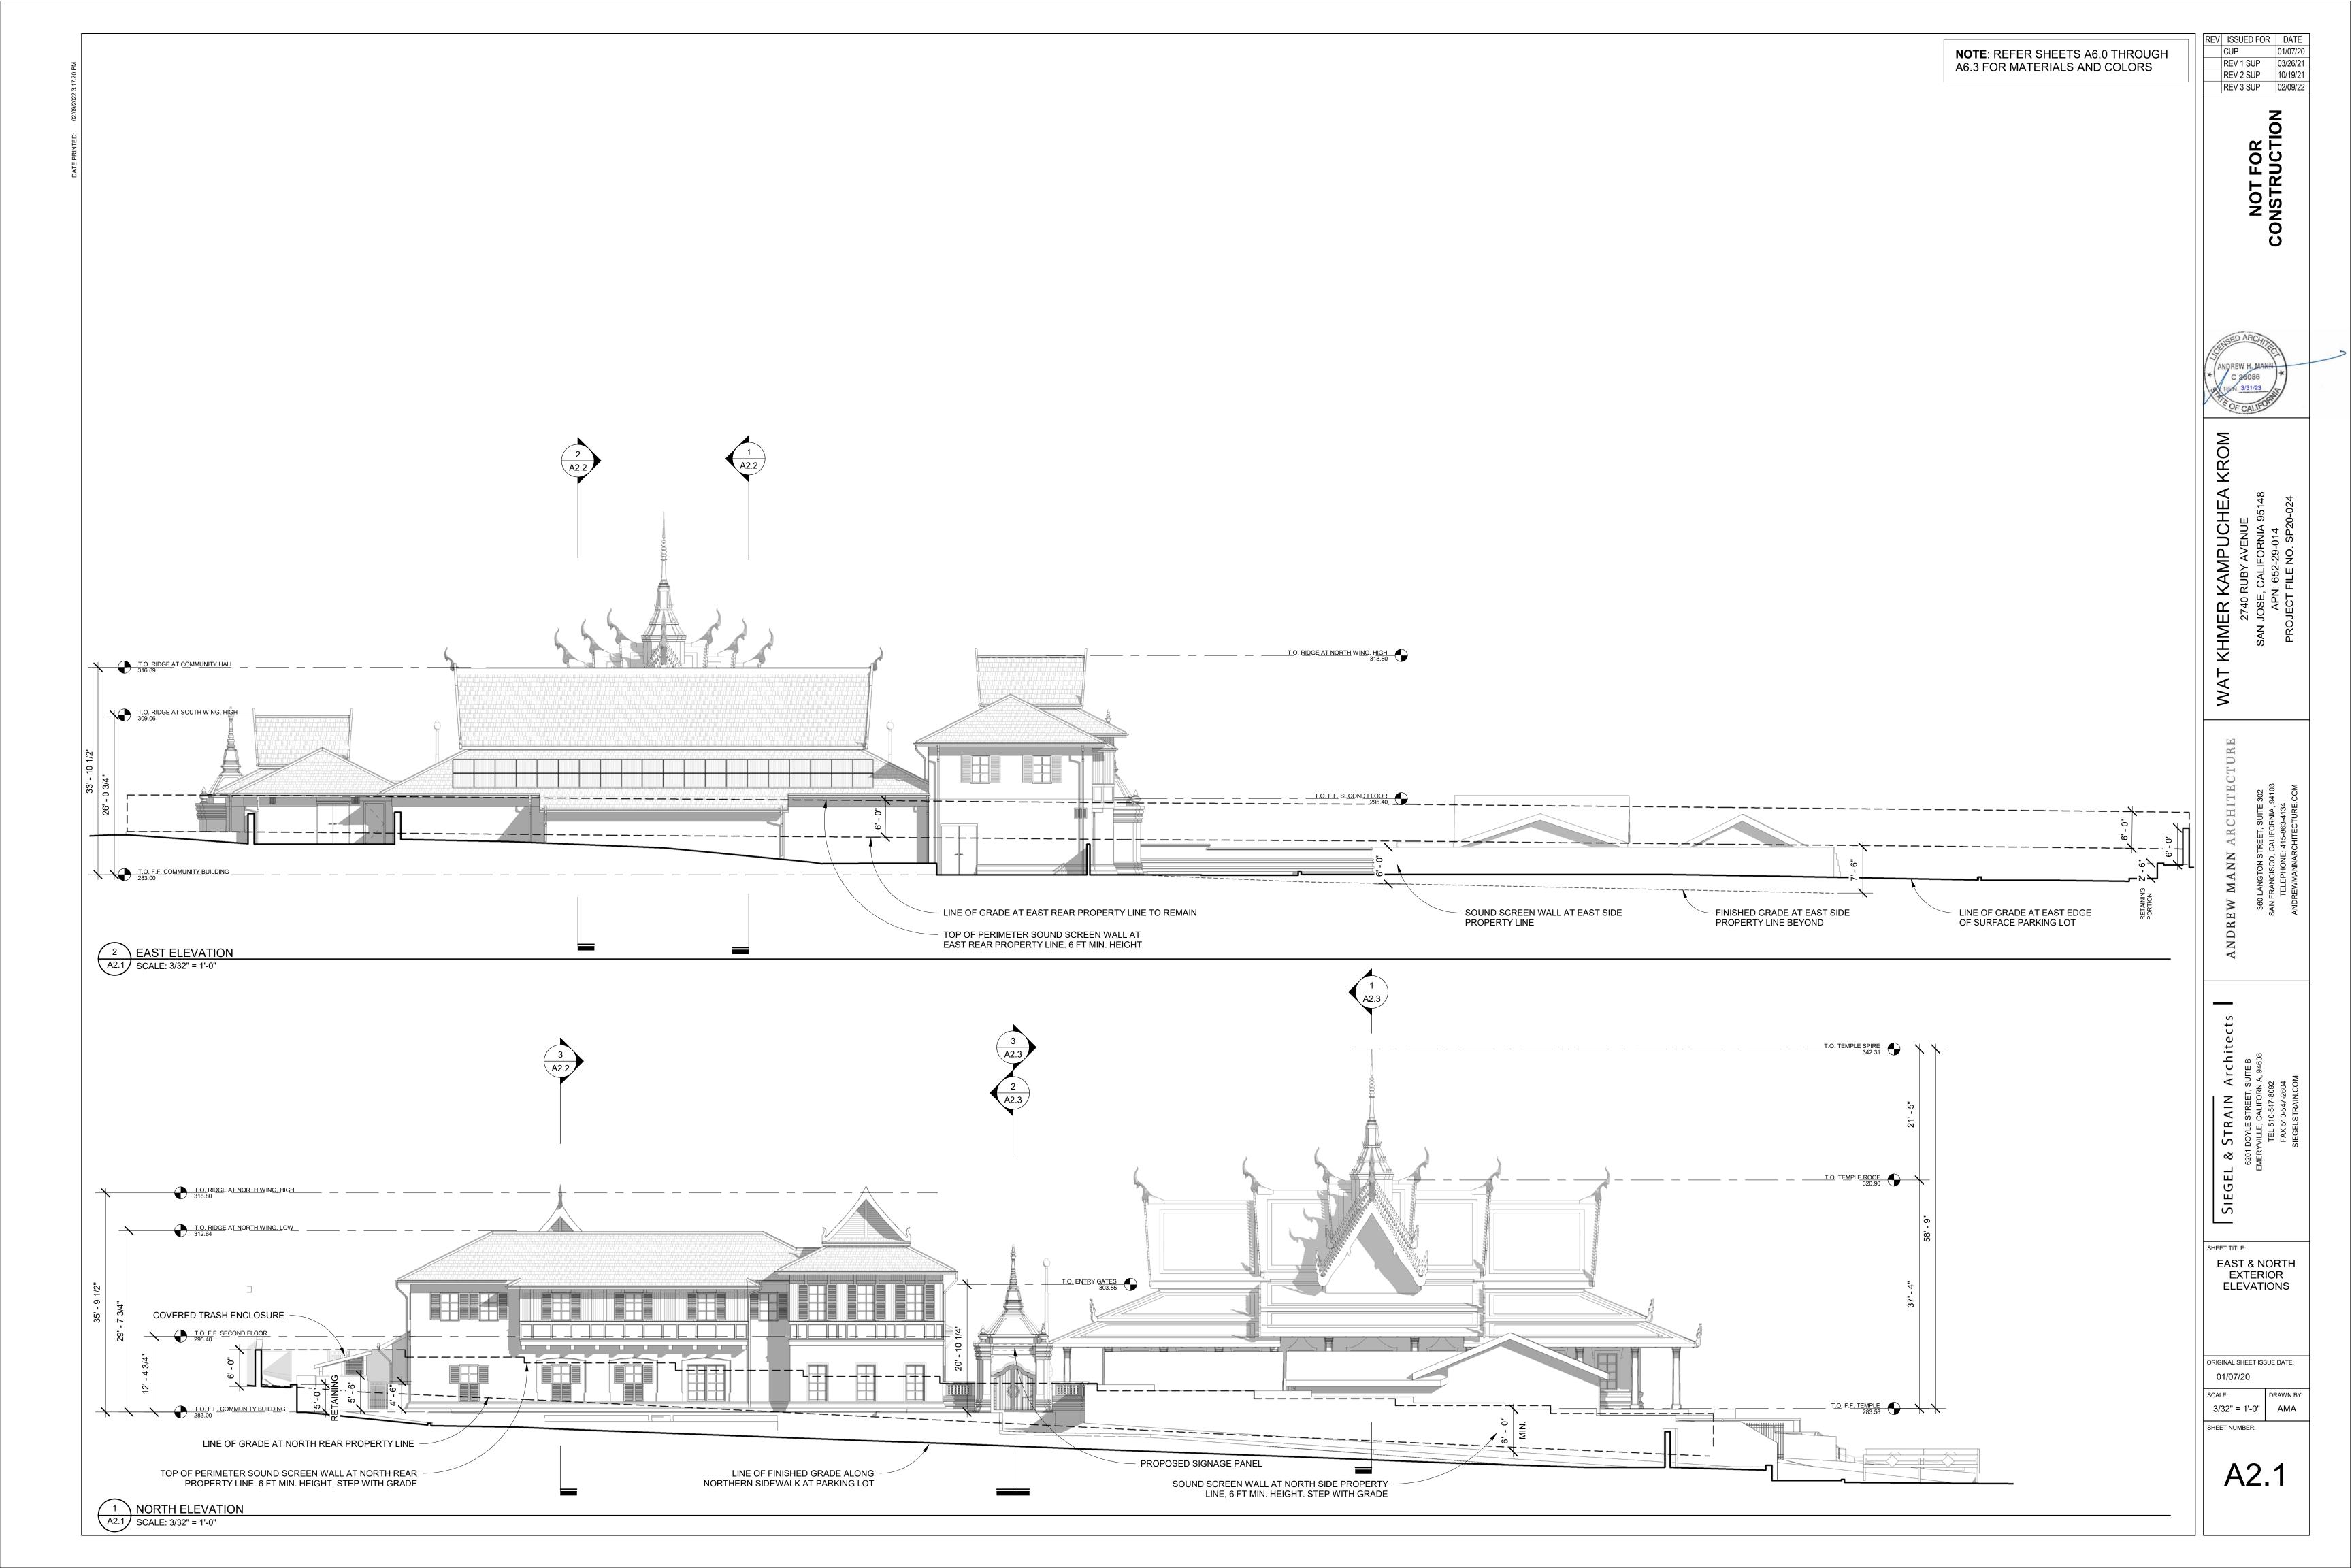

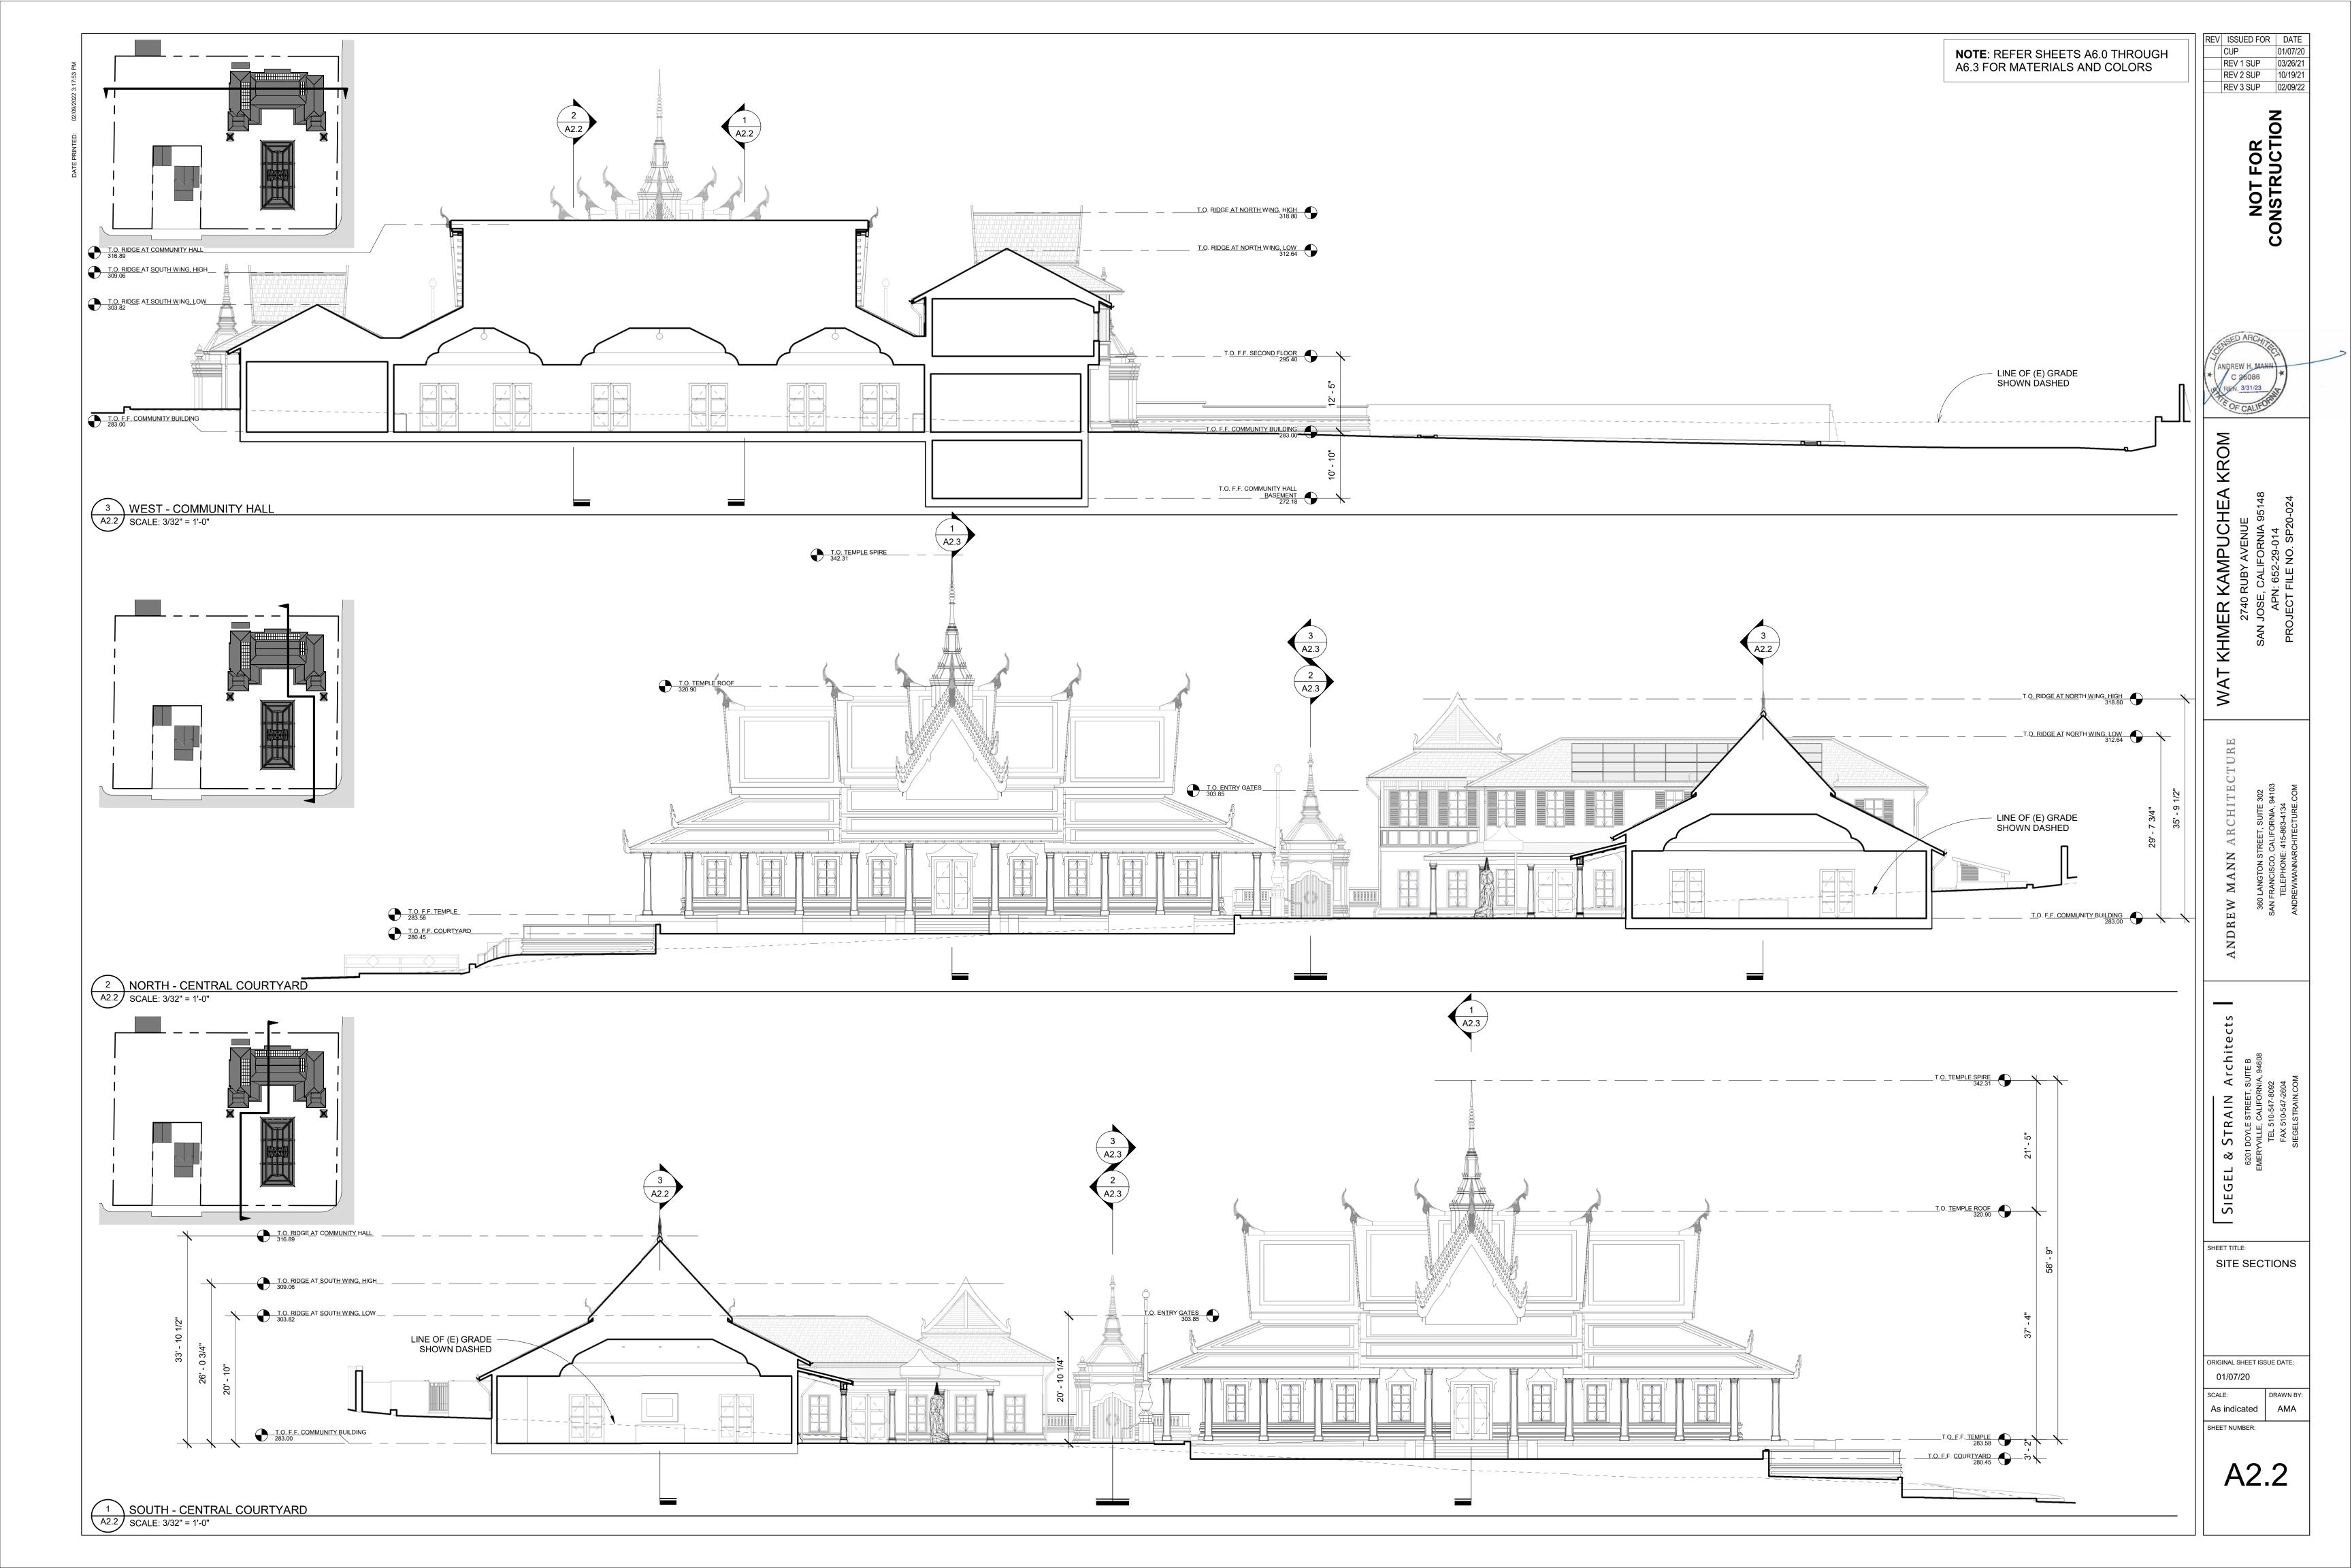

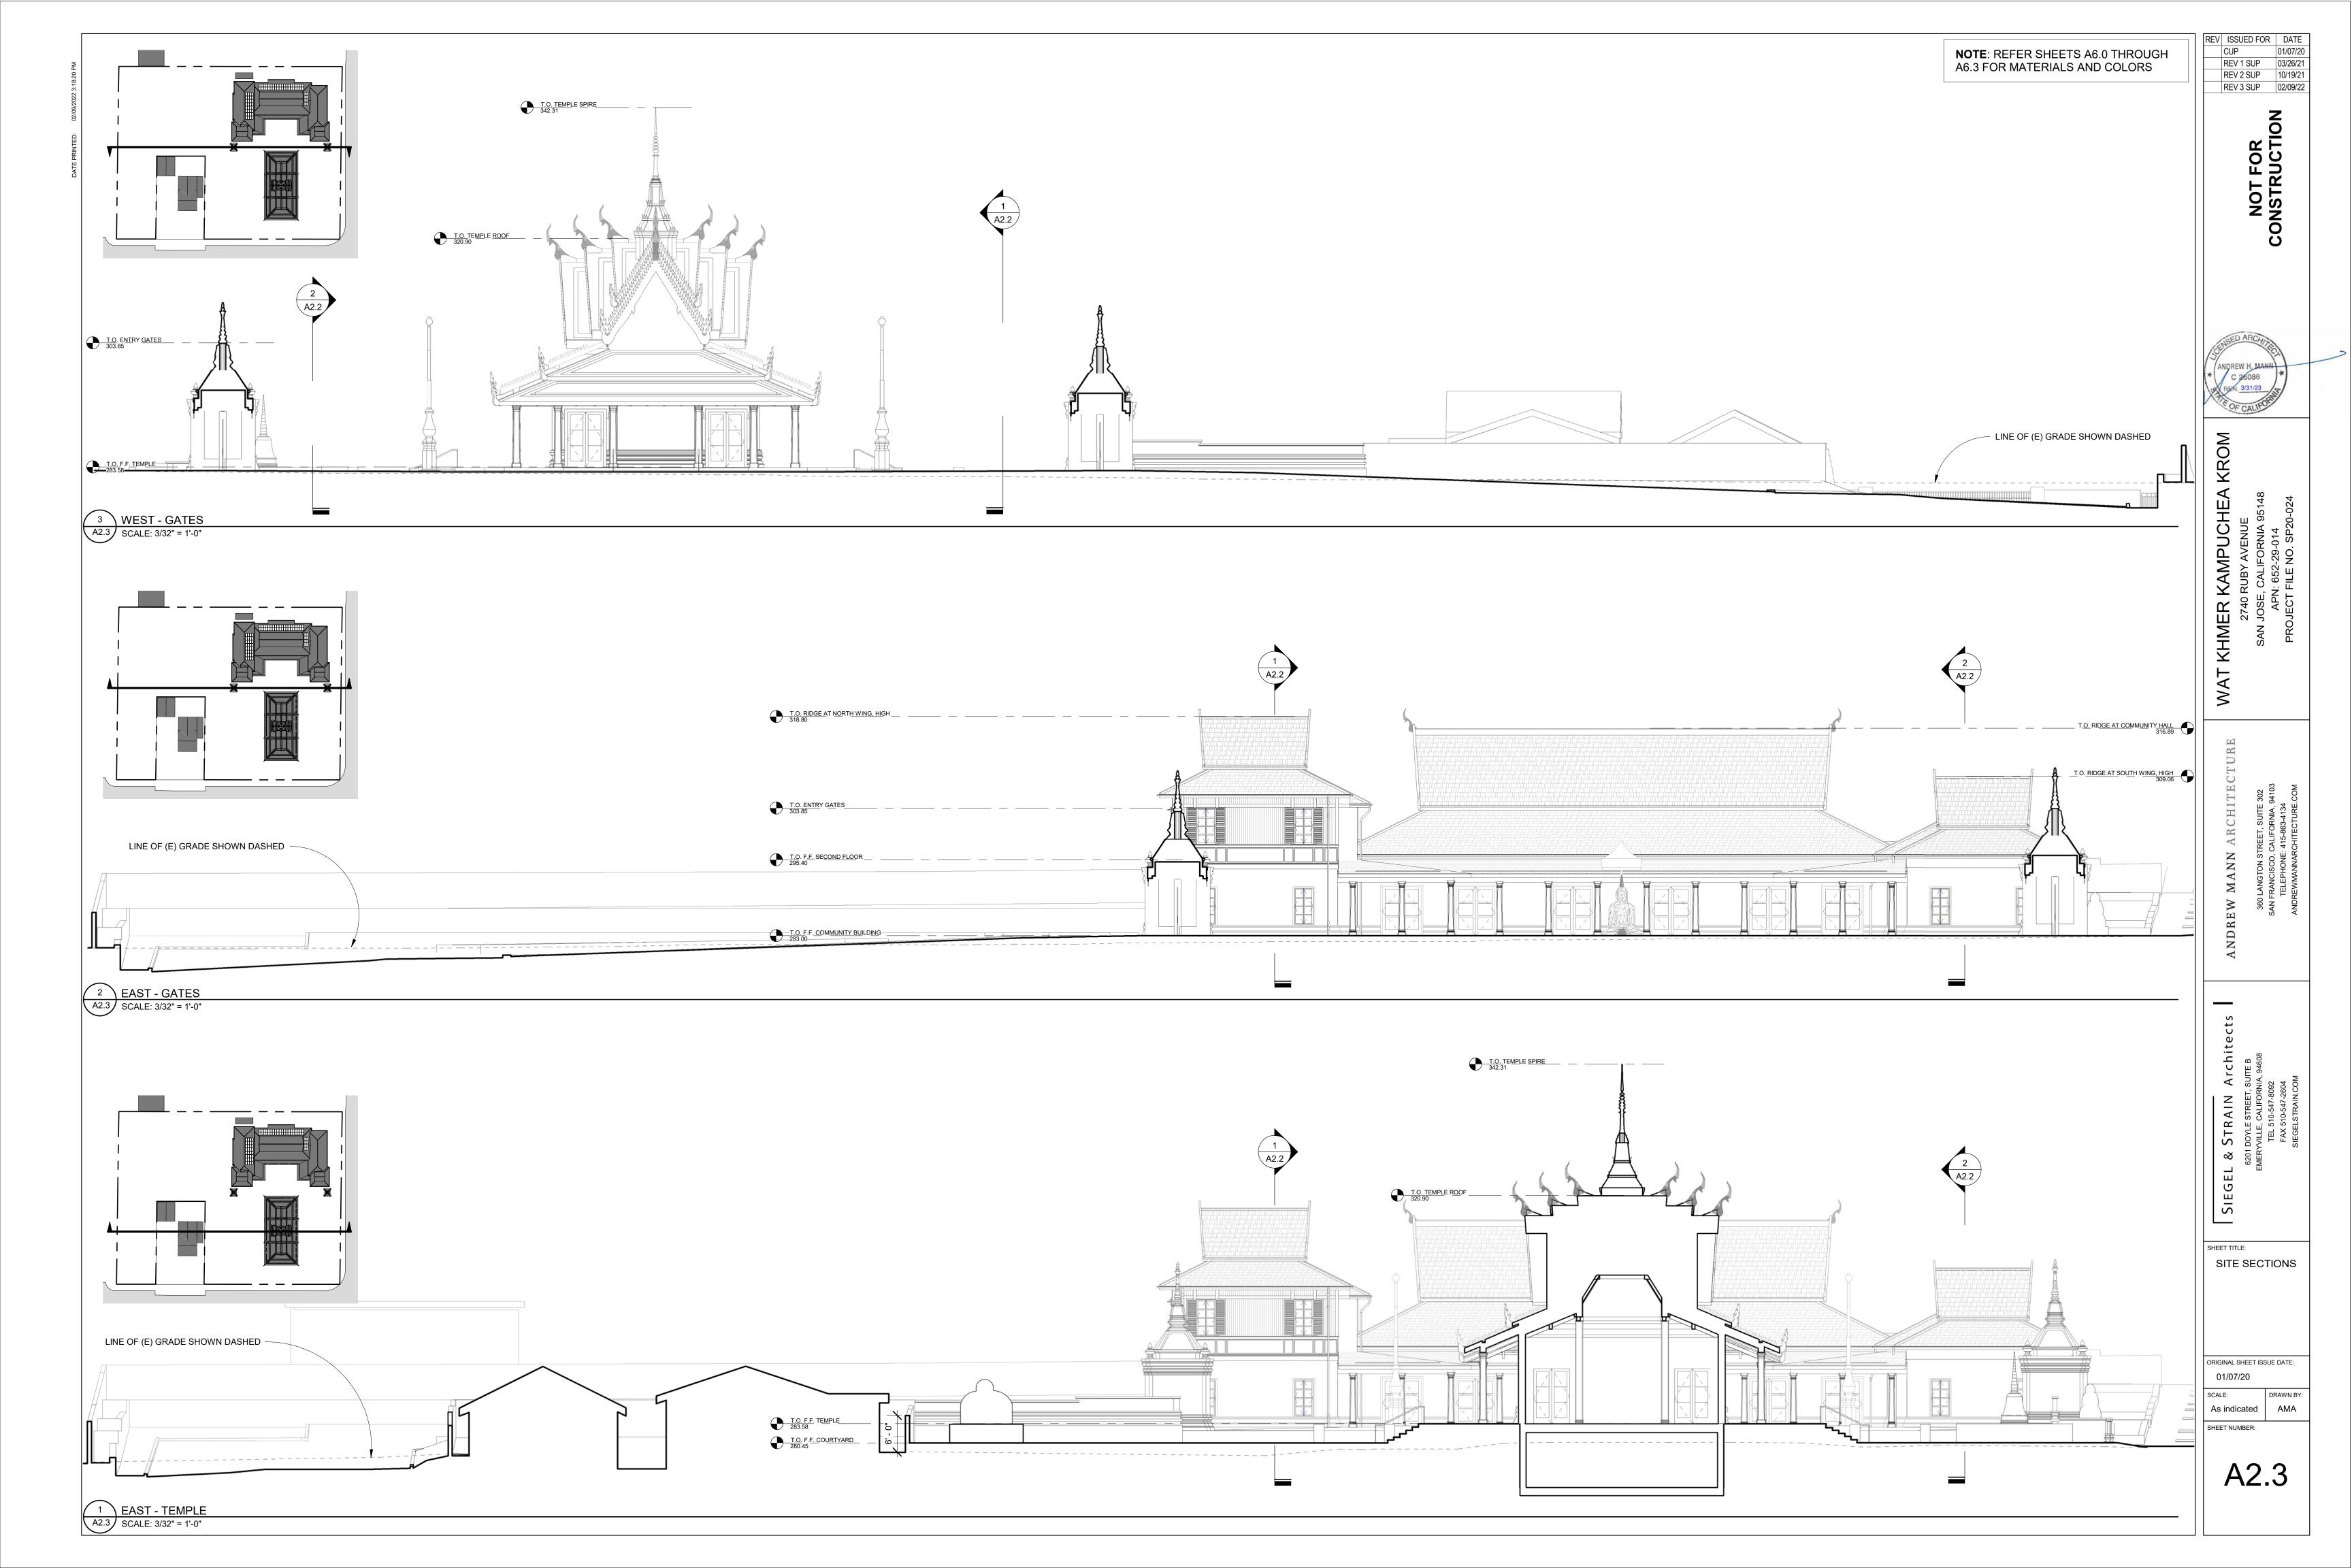



AERIAL VIEW (RENDERED VIEW ALSO LOCATED ON SHEET 0)



VIEW FROM RUBY AVENUE AT EYE LEVEL (RENDERED VIEW ALSO LOCATED ON SHEET G7.3)



A5.0



VIEW FROM NORWOOD AT EYE LEVEL LOOKING WEST




VIEW OF KITCHEN, OFFICE/MEETING, & MONK'S RESIDENCE AT EYE LEVEL FROM SURFACE PARKING LOT (RENDERED VIEW ALSO LOCATED ON SHEET G7.2)





VIEW OF ENTRY GATE & CLASSROOM AT EYE LEVEL FROM NORWOOD AVENUE (RENDERED VIEW ALSO LOCATED ON SHEET G7.2)





VIEW OF TEMPLE AT EYE LEVEL FROM NORWOOD AVENUE (RENDERED VIEW ALSO LOCATED ON SHEETS G7.2 & G7.3)

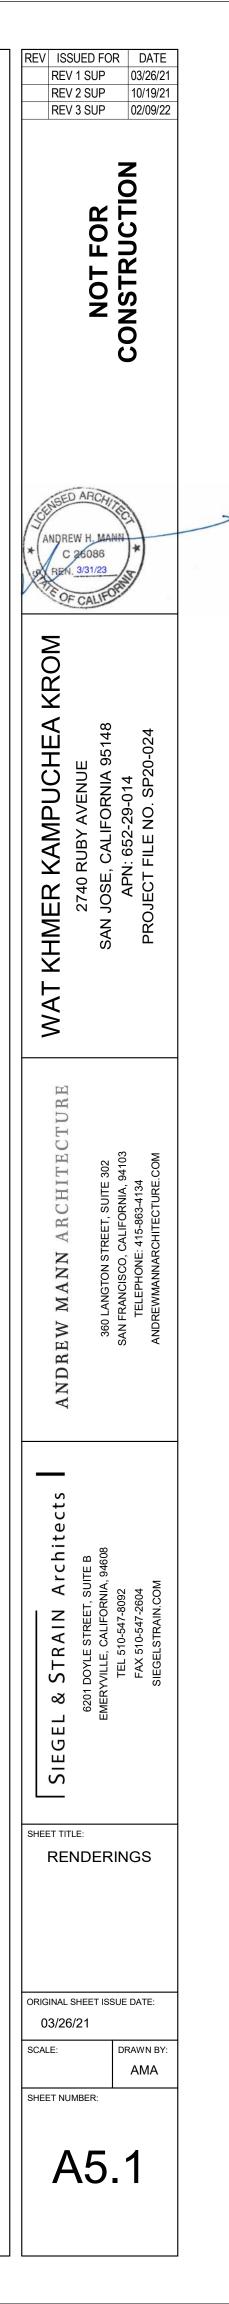

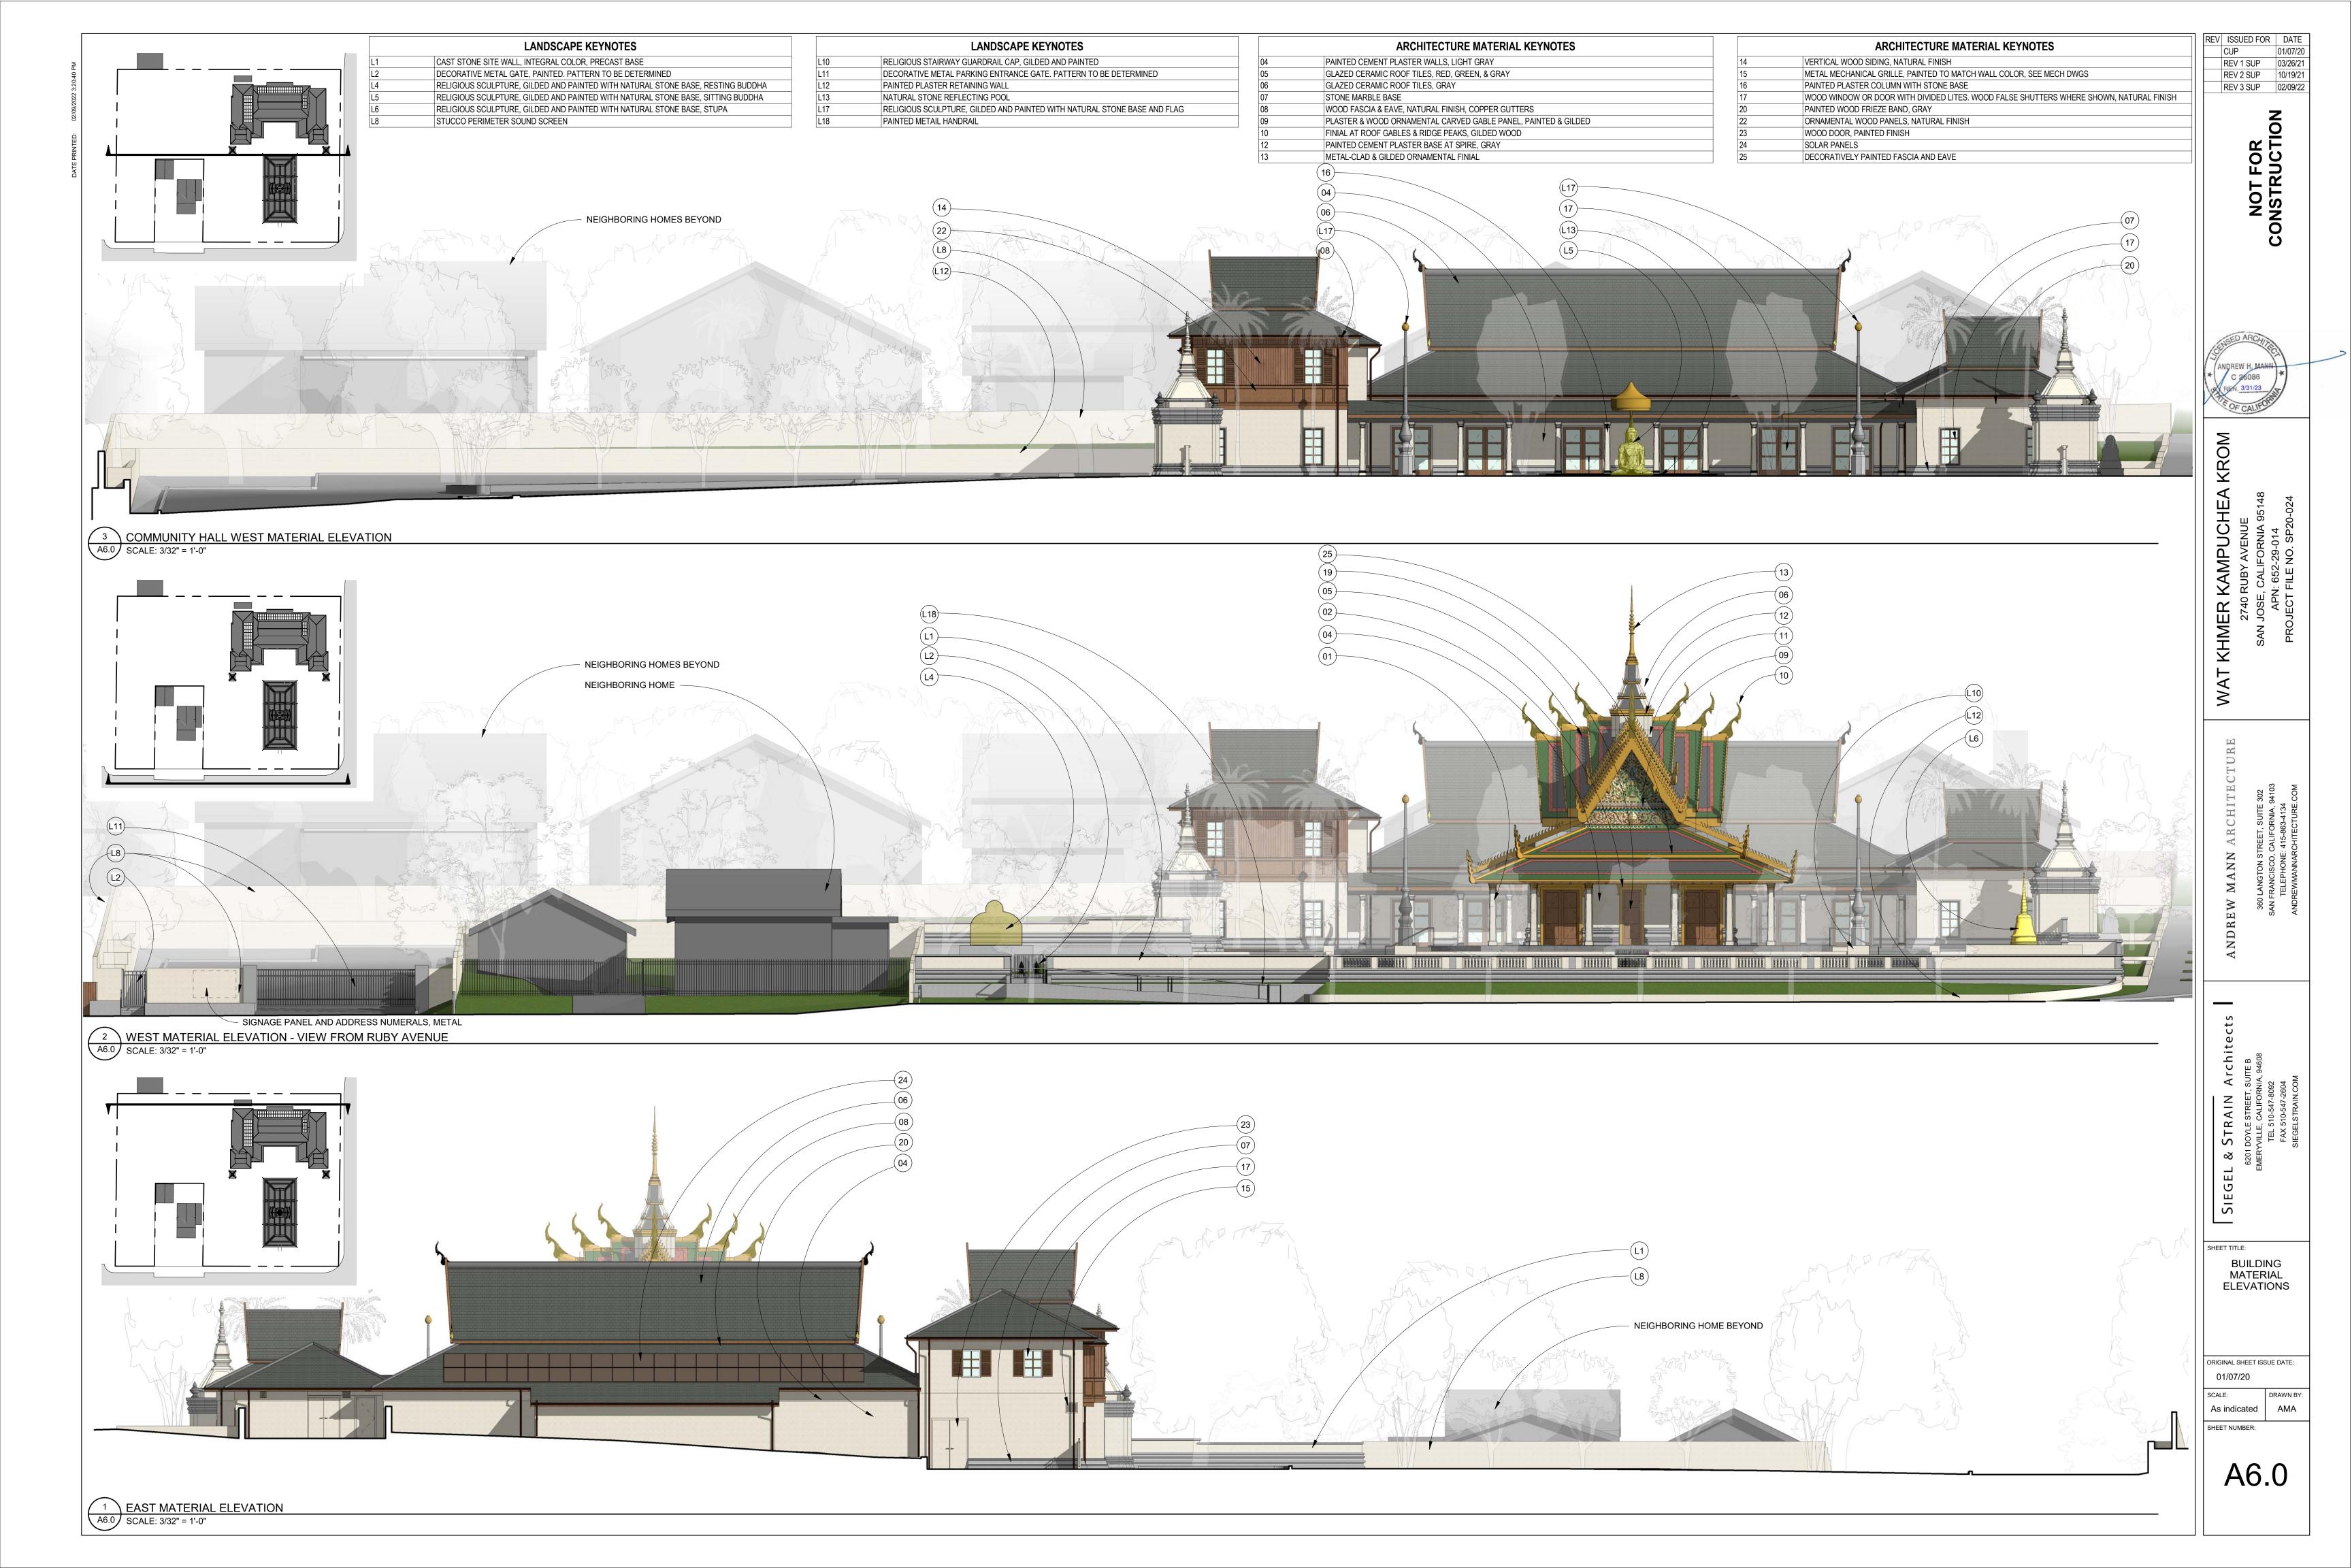

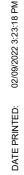

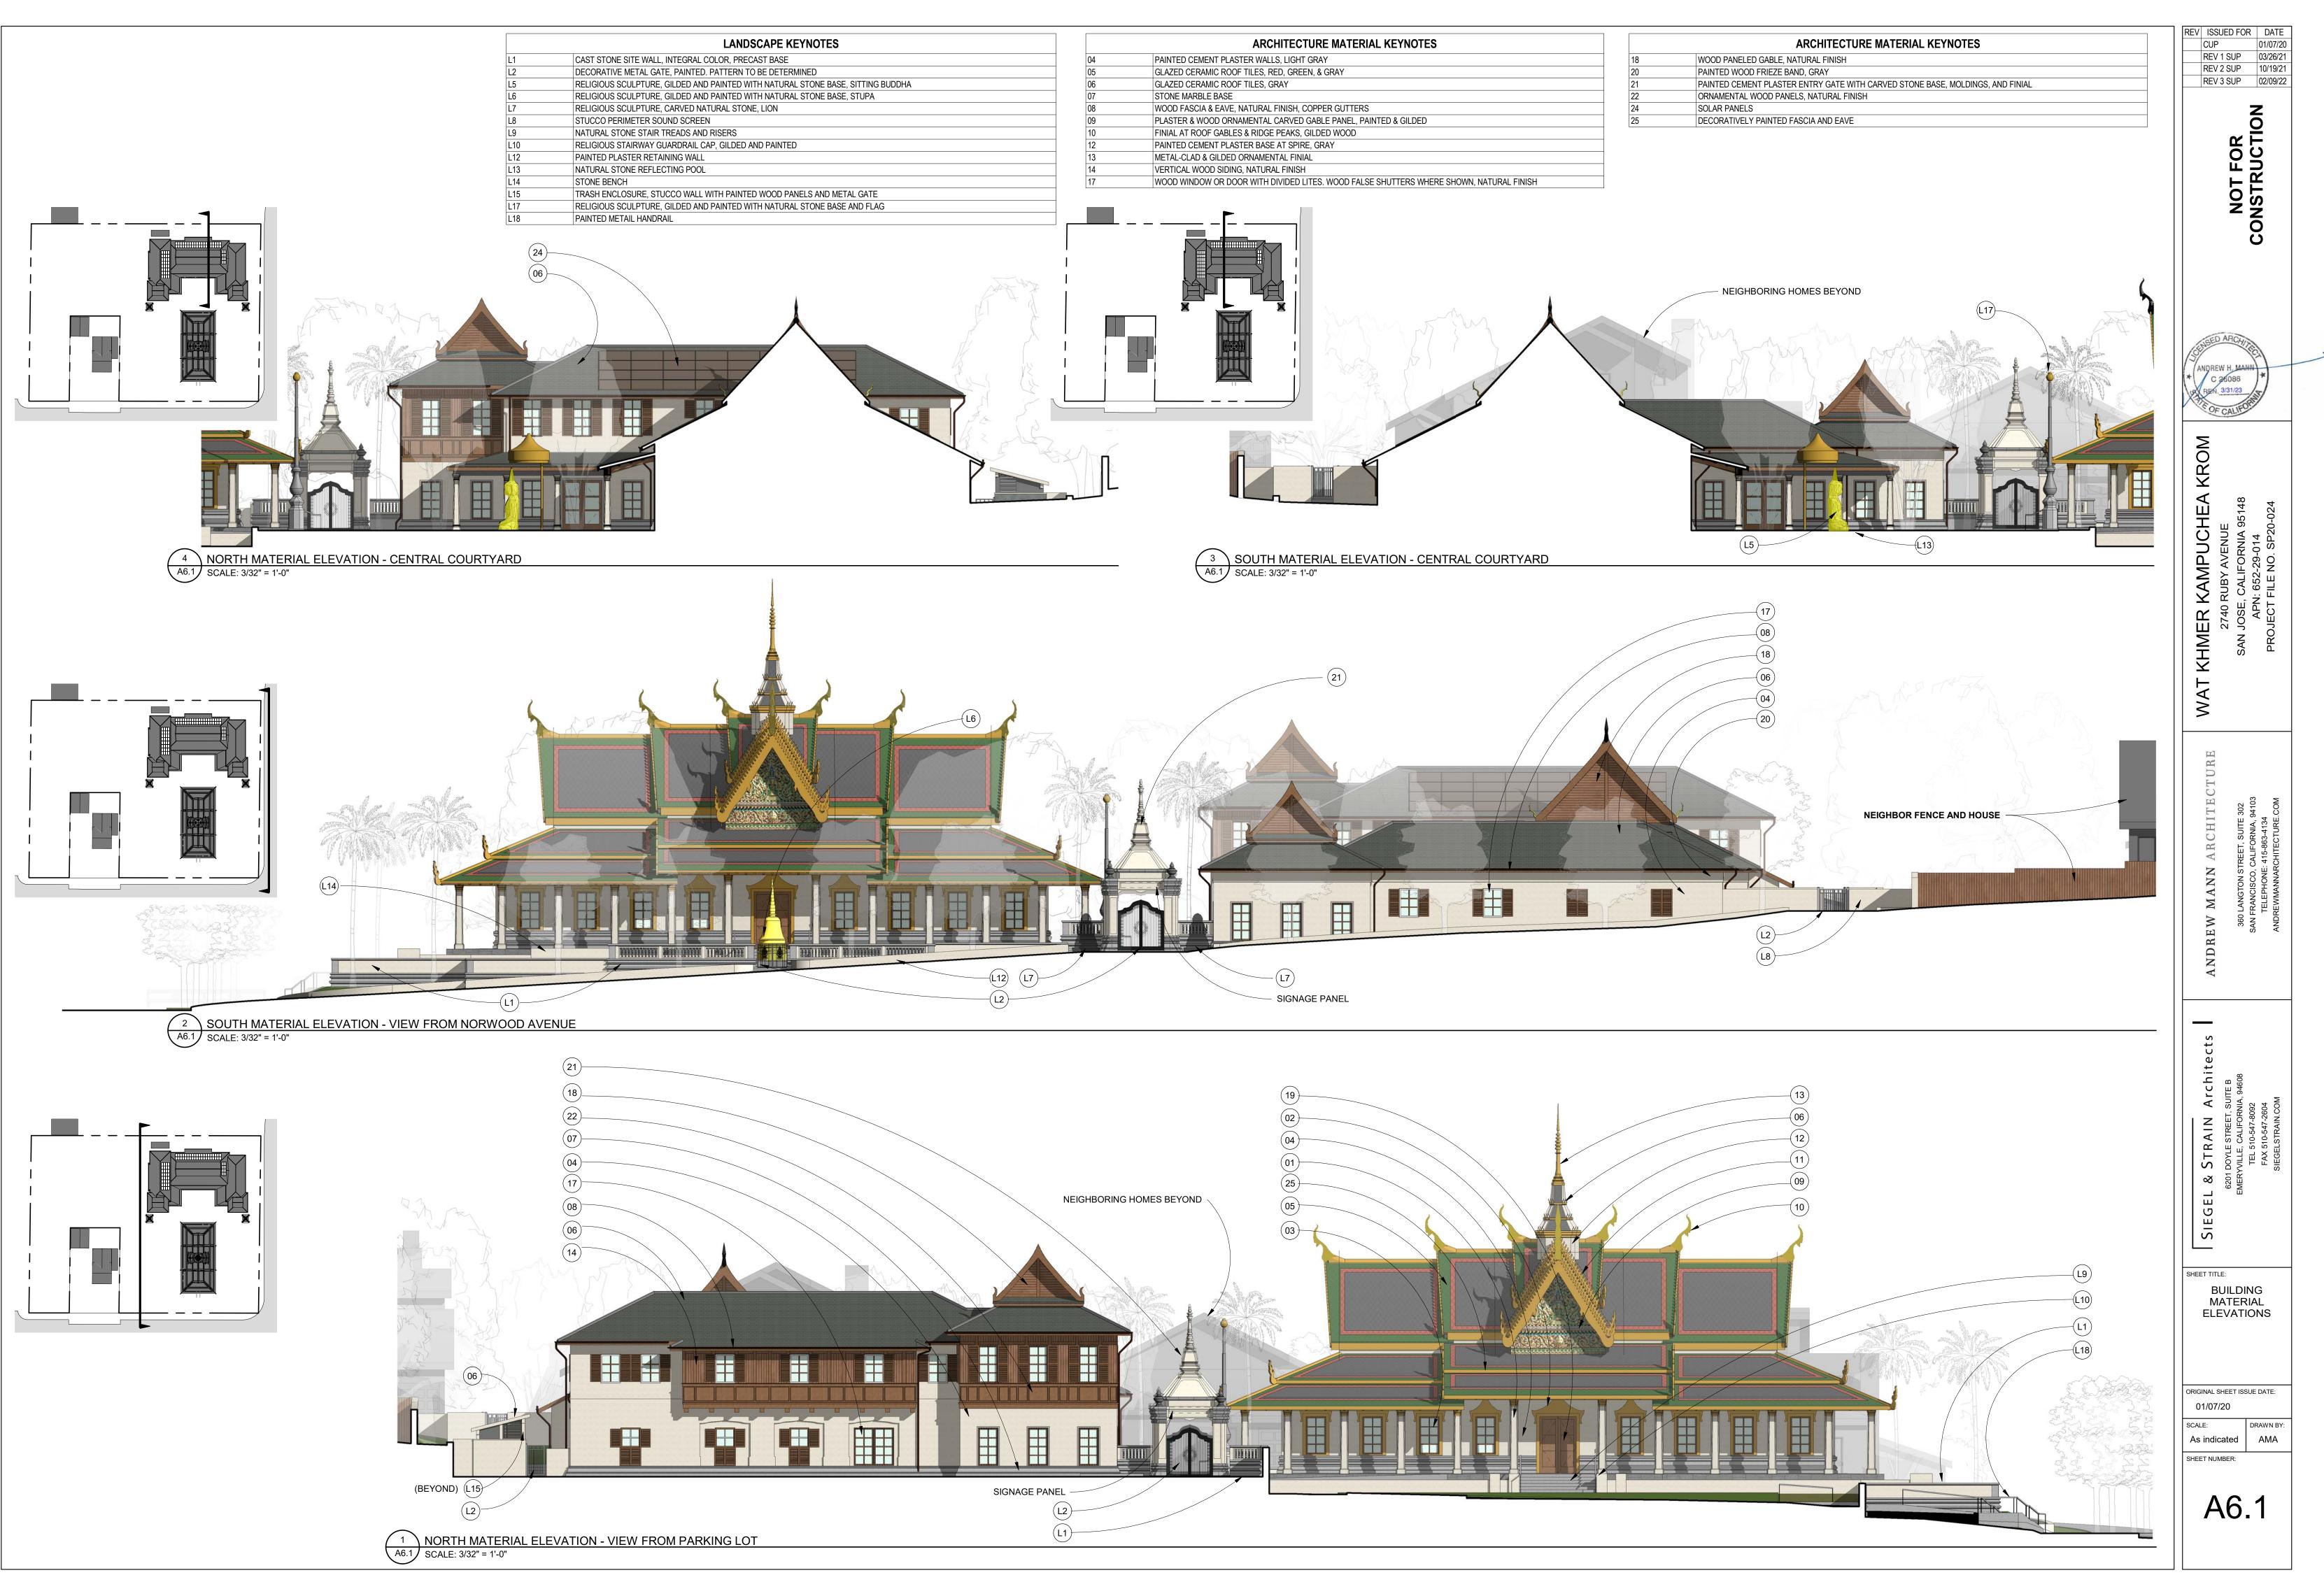

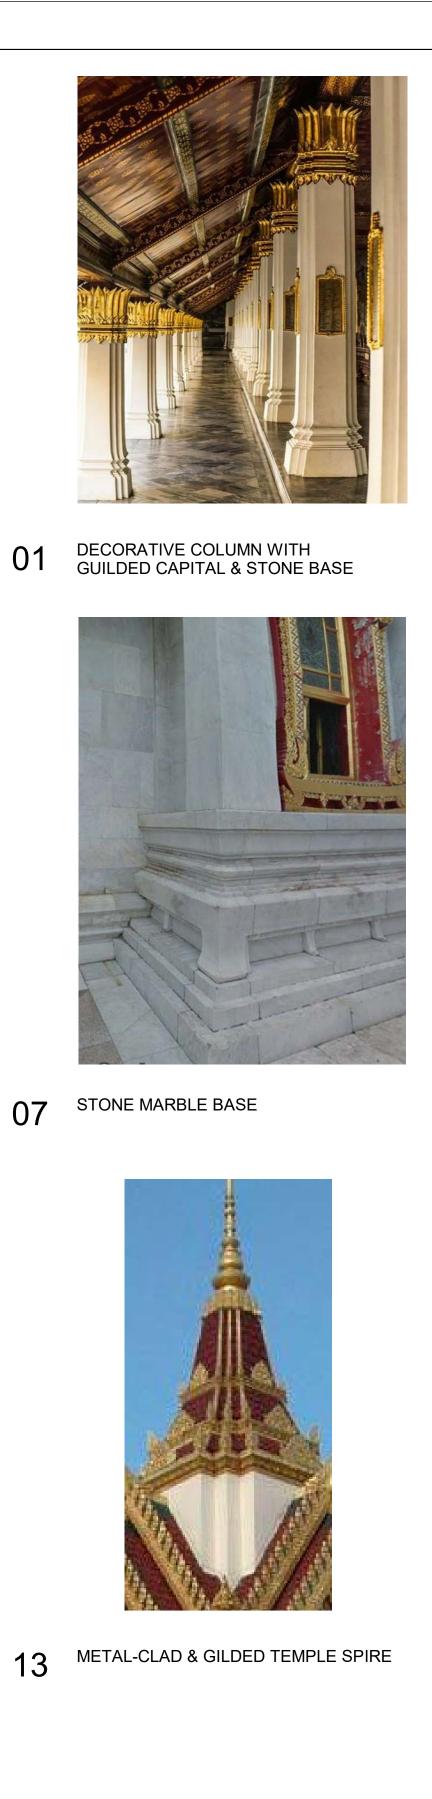







08 PAINTED WOOD FASCIA & EAVE, COPPER GUTTERS



14 VERTICAL WOOD SIDING; NATURAL FINISH









21 CARVED NATURAL STONE ENTRYWAY



03 wood painted window; gray





09 PLASTER & WOOD ORNAMENTAL CARVED GABLE PANEL, PAINTED & GILDED




04 PAINTED CEMENT PLASTER WALLS; LIGHT GRAY





16 PAINTED PLASTER COLUMN WITH STONE BASE

10 FINIAL AT ROOF GABLES & RIDGE PEAKS, GILDED WOOD

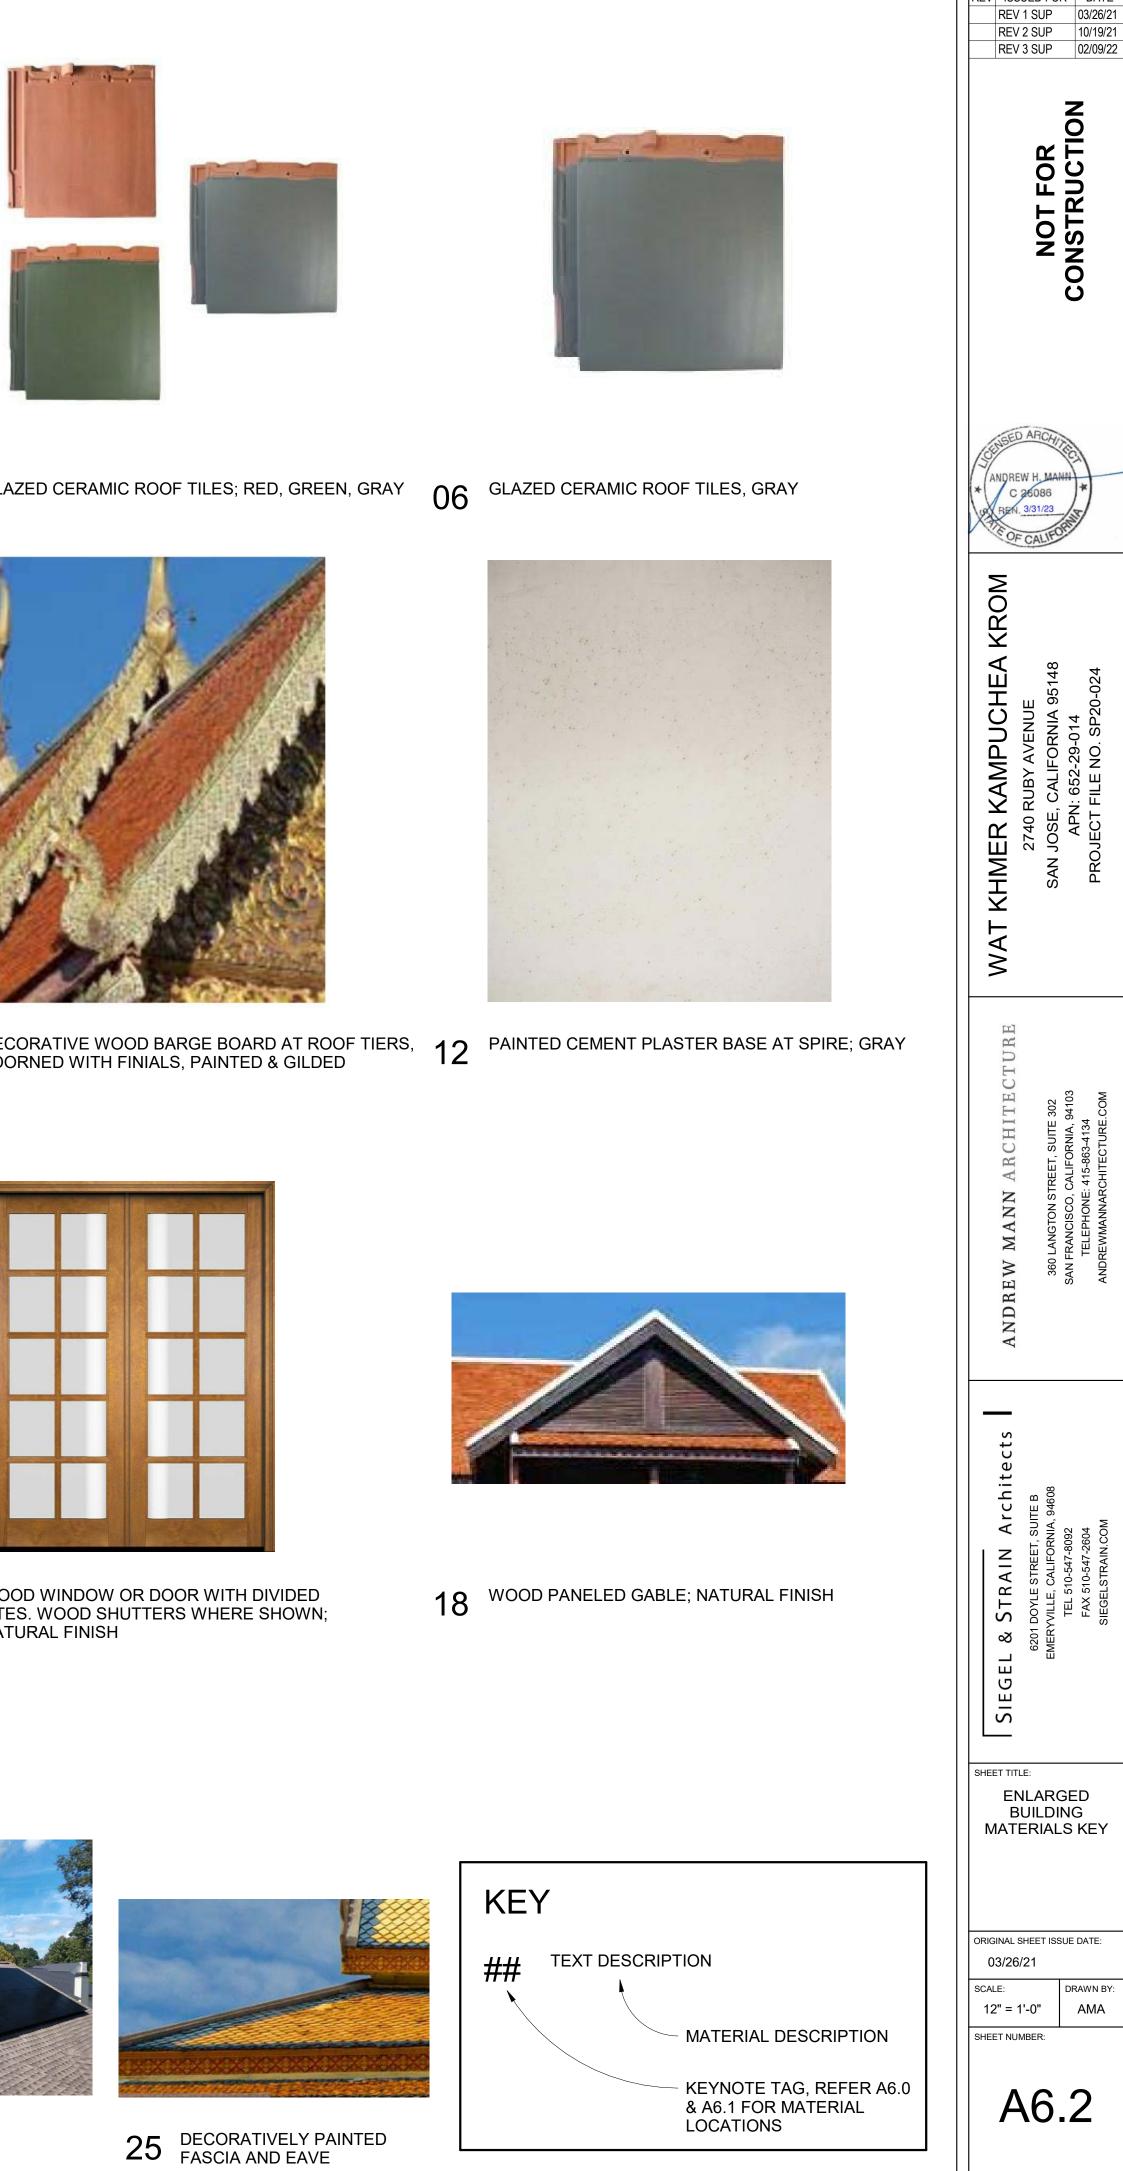

REV ISSUED FOR DATE

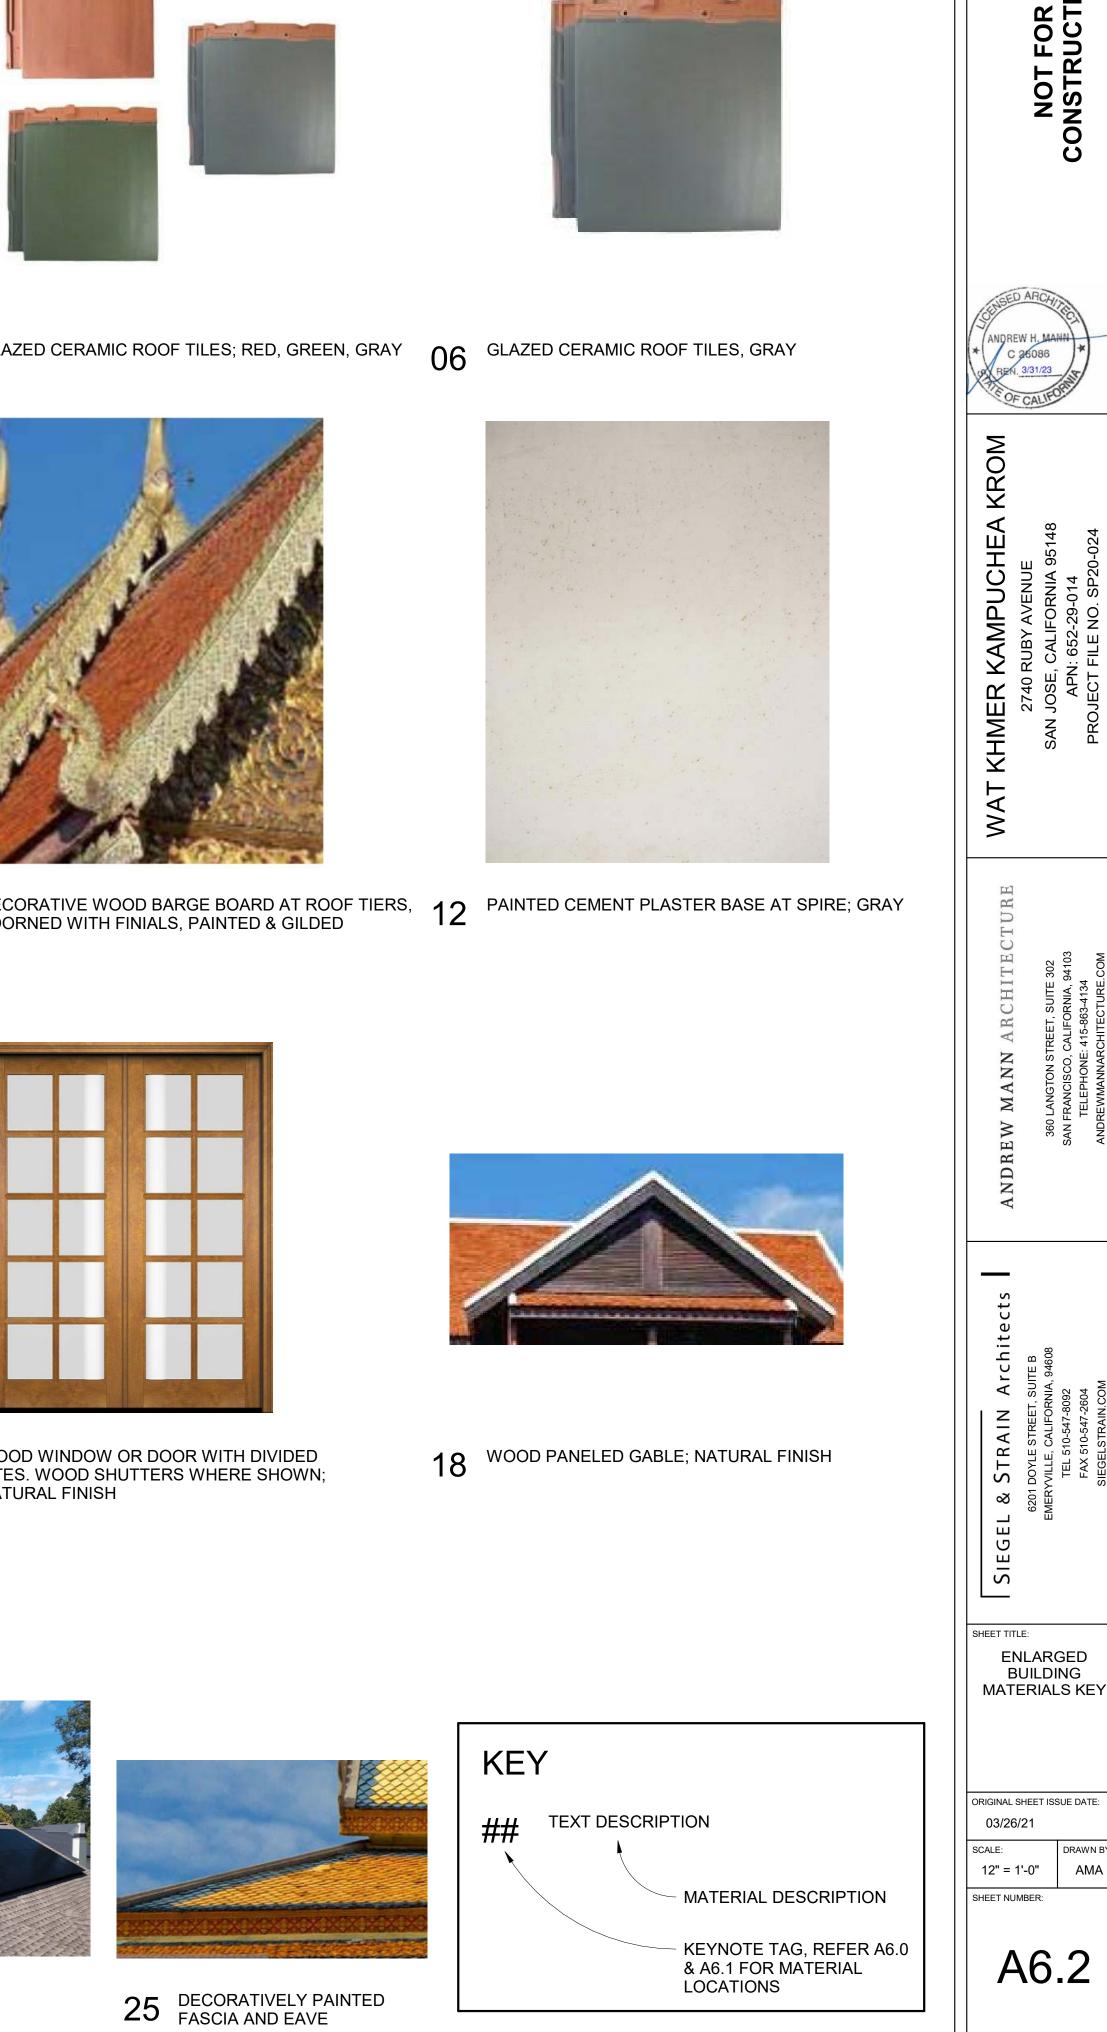

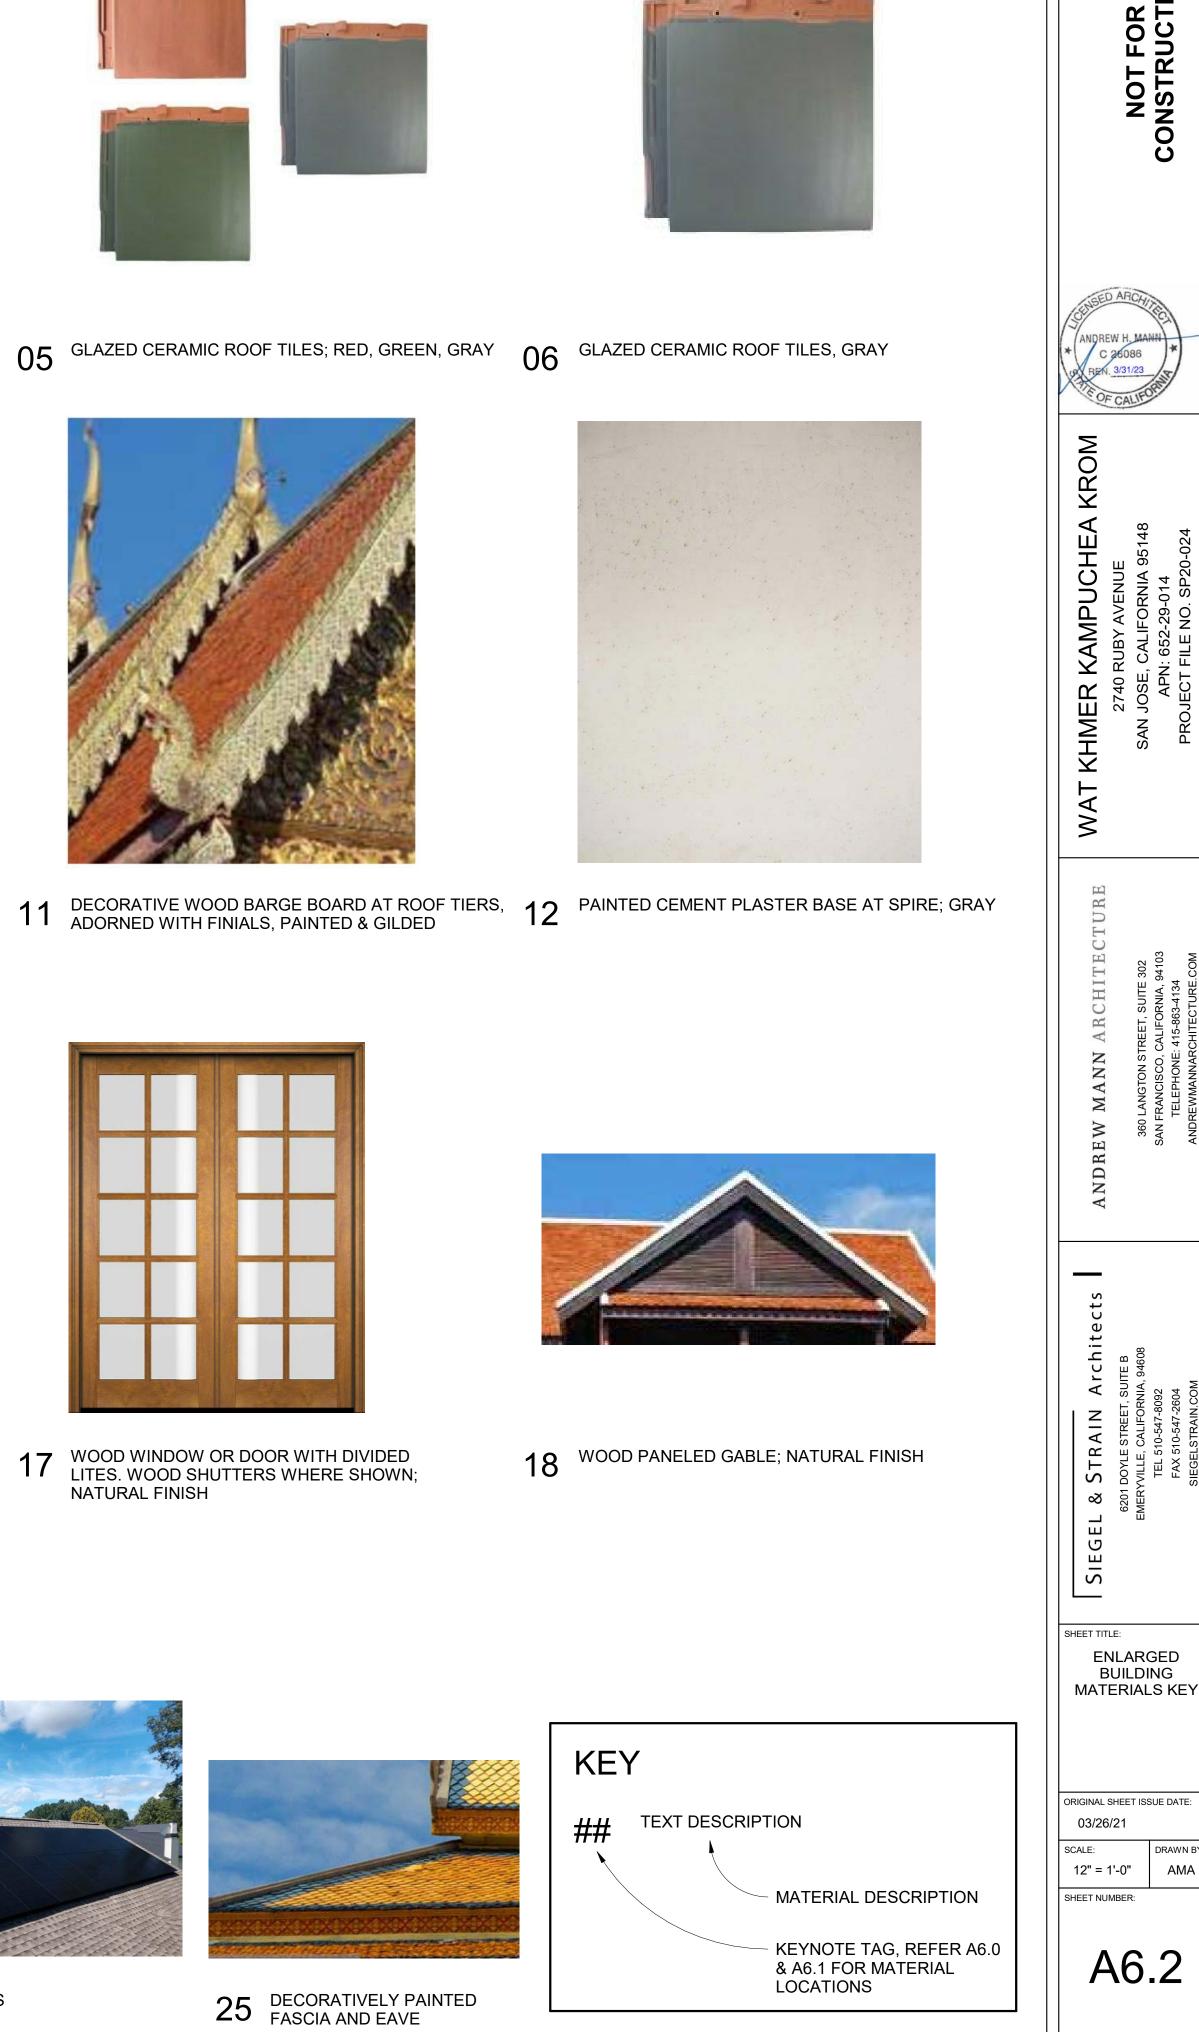



15 DECORATIVE METAL MECHANICAL GRILLE, PAINTED TO MATCH WALL COLOR






22 ORNAMENTAL WOOD PANELS; 23 WOOD DOOR, NATURAL FINISH





24 SOLAR PANELS

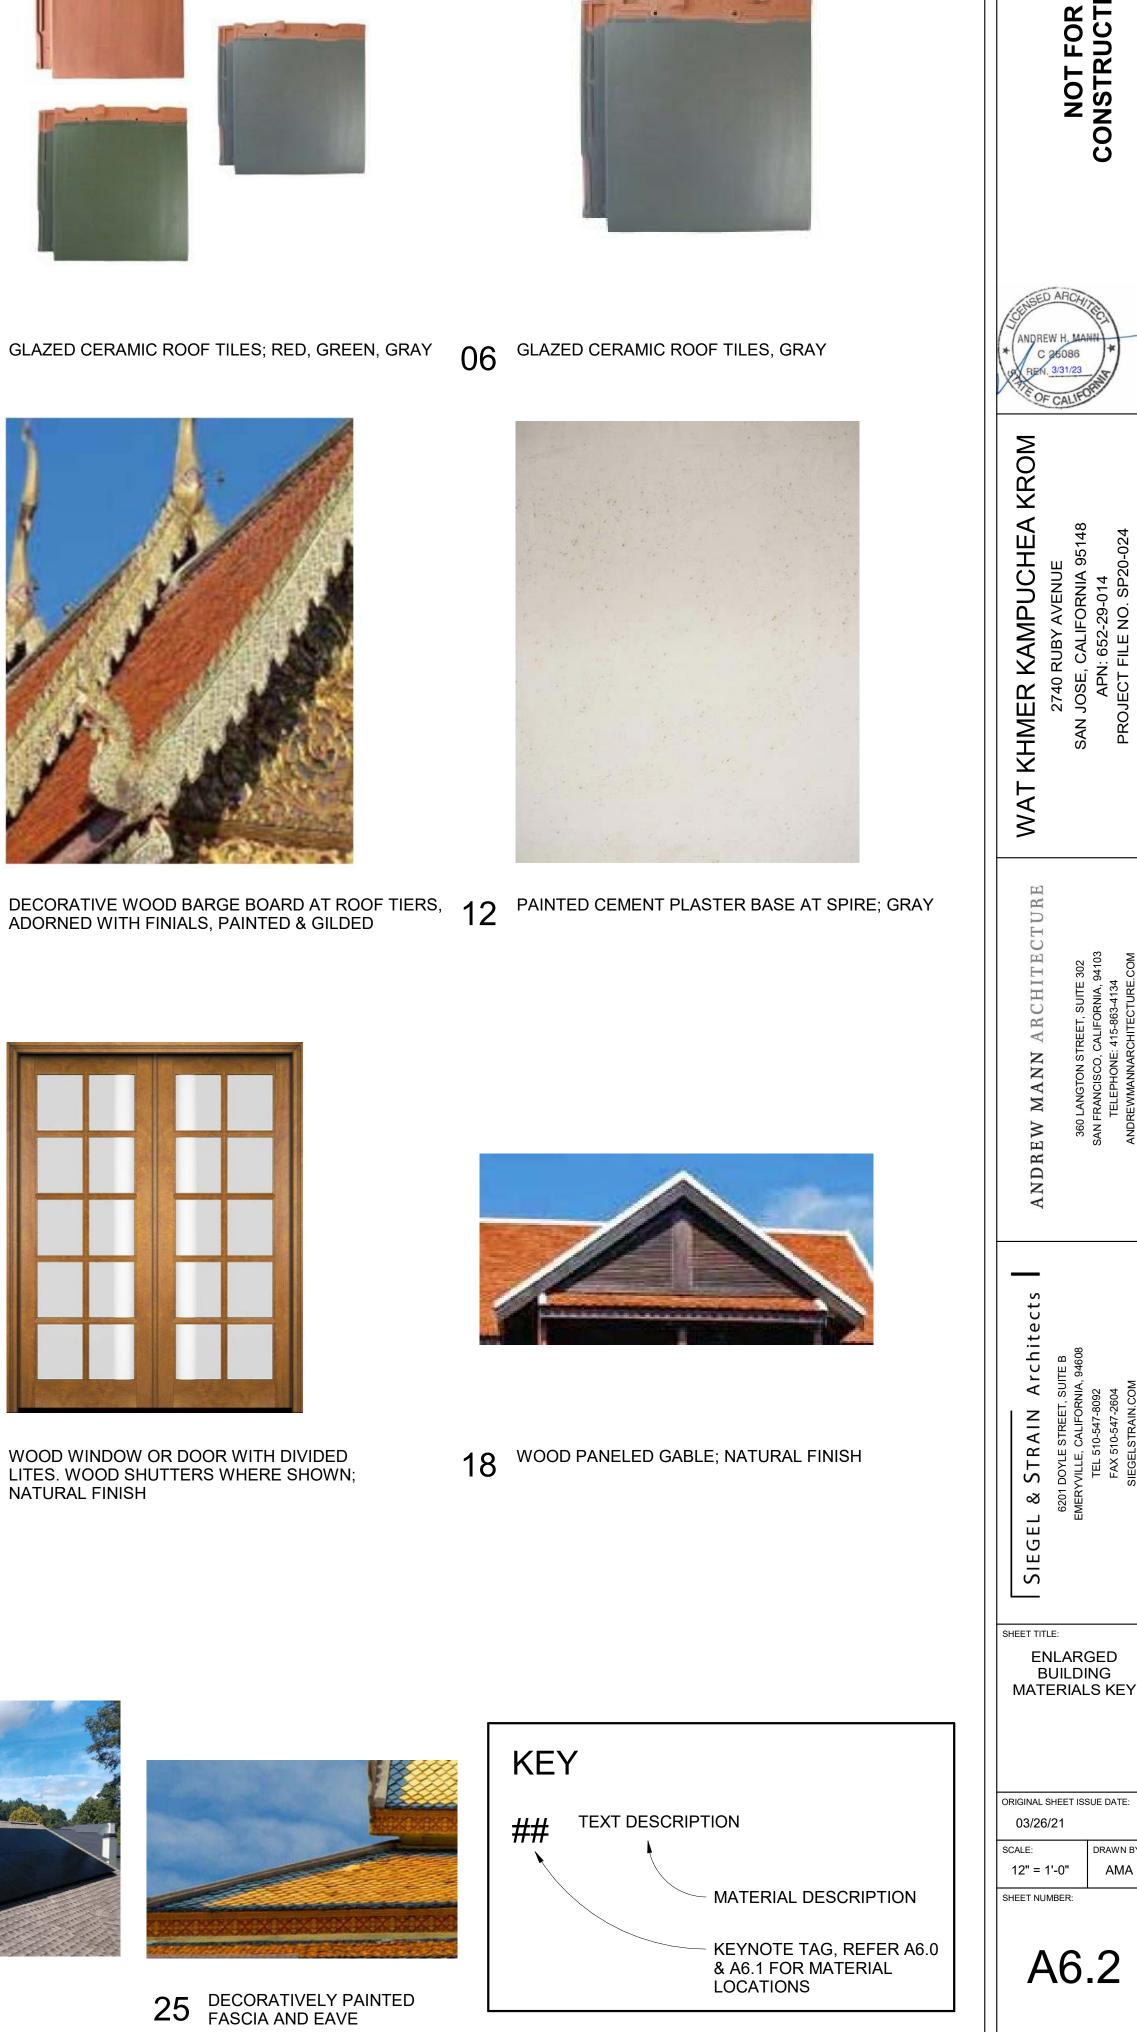



L1 CAST STONE SITE WALL, INTEGRAL COLOR, PRECAST BASE



L2 DECORATIVE METAL GATE, PAINTED. PATTERN TO BE DETERMINED



RELIGIOUS SCULPTURE, CARVED NATURAL STONE: LION L7



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L8 STUCCO PERIMETER SOUND SCREEN
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L13 NATURAL STONE REFLECTING POOL



L14 STONE BENCH


L15 TRASH ENCLOSURE; STUCCO WALL WITH METAL GATE

L9 NATURAL STONE STAIR TREADS AND RISERS



L16 CARVED NATURAL STONE RELIGIOUS SCULPTURE

L17 RELIGIOUS SCULPTURE, GILDED AND PAINTED WITH NATURAL STONE BASE AND FLAG

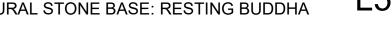











L10 RELIGIOUS STAIRWAY GUARDRAIL CAP, GILDED & PAINTED



L3 PAINTED METAL GUARDRAIL







L5 RELIGIOUS SCULPTURE, GILDED & PAINTED WITH NATURAL STONE BASE: SITTING BUDDHA



L6 RELIGIOUS SCULPTURE, GILDED & PAINTED WITH NATURAL STONE BASE: STUPA

L11 DECORATIVE METAL PARKING ENTRANCE GATE. PATTERN TO BE DETERMINED




L12 PAINTED PLASTER RETAINING WALL





L18 PAINTED METAL HANDRAIL



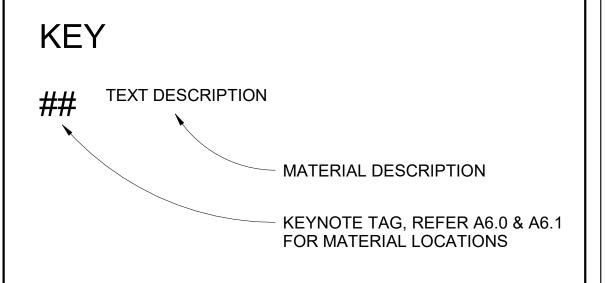

REV ISSUED FOR DATE REV 1 SUP 03/26/21 REV 2 SUP 10/19/21 REV 3 SUP 02/09/22	
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